



			Scale	AS NOTED		
			Date	OCTOBER 2018		
			Job No.	271-1607		
03	10/19/18	REVISED FINAL SUBMISSION	Designed by	JRC	THIS LINE IS ONE INCH LONG WHEN PLOTTED	_
02	08/22/18	FINAL SUBMISSION	Drawn by	KMB	AT FULL SCALE ON A	
01	08/01/18	DRAFT PRELIMINARY DESIGN SUBMISSION	Checked by	BLH	22" X 34" DRAWING	
MARK	DATE	DESCRIPTION	Approved by	JDF		

TRAFFIC SIGNS AND PAVEMENT MARKINGS PLAN - 09

IDENTIFICATION NUMBER		OF SIGN CHES)	TEXT		MENSIONS CHES)	NUMBER OF	COI	_OR	POST SIZE  AND	UNIT	TOTAL AREA
	WIDTH	HEIGHT		LETTER HEIGHT	VERTICAL SPACING	SIGNS	BACK- LEGI	END BORDER	NUMBER REQUIRED	IN SQUARE FEET	IN SQUARE FEET
B2	24	18	BICYCLE STOP ON LINE FOR GREEN	MAS: STAN	SDOT IDARD	4	MAS	SDOT IDARD	P5 (4)	3	12
В3	18	18		MASS STAN	SDOT DARD	4	MAS STAN	SDOT IDARD	MOUNT WITH B2	2.25	9
D3-1			RENDEZVOUS LN			R&R (2)			P-5 (1)	NA	NA
D3-2			PINE LN			R&R (1)			P5 (1)	NA	NA
D3-3			RAILROAD AVE			R&R (1)			P5 (1)	NA	NA
D3-4			WINDSOR WAY			R&R (2)			P5 (1)	NA	NA
D3-5			TO HYANNIS -			R&R (1)			P5 (1)	NA	NA
D3-6			HYANNIS RD			R&R (1)			MOUNT WITH D3-4	NA	NA
D3-7			₩ MILLWAY			R&R (2)			P5 (1)	NA	NA
D3-8			MAIN ST\RTE 6A			R&R (2)			MOUNT WITH D3-6	NA	NA
D3-9			FREEZER RD			R&R (2)			P5(1)	NA	NA
D6			6A WEST  BARNSTABLE  VILLAGE			R&R (1)			5" NOM. STEEL PIPE 14.62LBS./FT (1)	EACH	EACH
D8			6A EAST CUMMAQUD			R&R (1)			MOUNT WITH D6	EACH	EACH
D11-1	24	30	BIKE ROUTE	MU' STAN	TCD IDARD	1	MU STAN	TCD IDARD	P5 (1)	5.00	5.00
I-8	30	30				2			P5 (2)	6.25	12.50
M7-1R	12	9				1			MOUNT WITH D11-1	0.75	0.75
R1-1	30	30	STOP			2			P5 (2)	6.25	12.50
R2-1*	18	24	SPEED LIMIT 25			5			P5 (5)	3.00	15.00

SEE MANUAL ON UNIFORM TRAFFIC CONTROL DEVICES 2009 EDITION WITH LATEST REVISIONS AND MASSACHUSETTS AMENDMENTS FOR LATEST SPECIFICATIONS ON TEXT DIMENSIONS AND COLOR.

\*25 MPH SPEED LIMIT PER TOWN DIRECTION

THE TOWN OF BARNSTABLE INTENDS TO R&R ALL STREET NAME (D3) SIGNS. ANY SIGNS DEEMED BY THE TOWN TO BE REPLACED WILL BE ADDRESSED OUTSIDE THE SCOPE OF THIS PROJECT.

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MASS.
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TRANSPORTATION IMPROVEMENTS ALONG MAIN STREET (ROUTE 6A) AND MILLWAY BARNSTABLE, MASSACHÚSETTS

TRAFFIC SIGN SUMMARY-01

NOT FOR CONSTRUCTION

IDENTIFICATION	SIZE C	OF SIGN			MENSIONS	NUMBER		00100		POST SIZE AND	UNIT AREA	TOTAL AREA
NUMBER	(INC	CHES)	TEXT	LETTER	CHES)  VERTICAL	OF SIGNS	BACK-	COLOR		NUMBER	IN SQUARE	
	WIDTH	HEIGHT		HEIGHT	SPACING	SIGNS	GROUND	LEGEND	BORDER	REQUIRED	FEET	FEET
R4-7	18	24		MUT STANI	CD DARD	2		MUTCD STANDARD		P5 (2)	3.00	6.00
R5-1	30	30	DO NOT ENTER			1				MOUNT WITH R6-1R	6.25	6.25
R6-1R	36	12	ONE WAY			1				P5(1)	3.00	3.00
R7-1D			NO NO NO			3				P5 (3)	1.50	4.50
R7-1L	12	18	NO NO PARKING PARKING ANY TIME TIME			2				P5 (2)	1.50	3.00
R7-1R			TIME TIME			4	-			P5 (4)	1.50	6.00
R7-5	12	18	ONE HOUR PARKING			1				P5 (1)	1.50	1.50
R10-6	24	36	STOP HERE ON RED			1				MOUNT WITH B2 &B3	6.00	6.00
R10-11A	24	30	NO TURN ON RED			4				P5 (4)	5.00	20.00
R12-5	24	36	WEIGHT LIMIT 8T 12T 16T			1				P5 (1)	6.00	6.00
W1-4R	30	30				1				P5 (1)	6.25	6.25
W3-5*	30	30	SPEED 125			1				P5 (1)	6.25	6.25
SP-1			STURGIS LIBRARY			R&R (2)				MOUNT WITH I-8	NA	NA
SP-2			BARNSTABLE COUNTY COUNTY COMPLEX PARKING			R&R (1)		_	_	P5 (1)	NA	NA
SP-3			STURGIS LIBRARY, COUNTY COMPLEX, GUARD HERITAGE MUSEUM			R&R (1)				P5 (1)	NA	NA
SP-4			PUBLIC TRANSIT TROLLEY/BUS STOP			R&R (1)				MOUNT WITH W11-1	NA	NA
SP-5			BLISH POINT STATE BOAT RAMP OPEN			R&R (1)				MOUNT WITH W12-5 & W16-9P	NA	NA

SEE MANUAL ON UNIFORM TRAFFIC CONTROL DEVICES 2009 EDITION WITH LATEST REVISIONS AND MASSACHUSETTS AMENDMENTS FOR LATEST SPECIFICATIONS ON TEXT DIMENSIONS AND COLOR.

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MARK	DATE	DESCRIPTION	Approved by	JDF

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TRANSPORTATION IMPROVEMENTS ALONG MAIN STREET (ROUTE 6A) AND MILLWAY BARNSTABLE, MASSACHUSETTS

TRAFFIC SIGN SUMMARY-02

NOT FOR CONSTRUCTION

Sheet No.

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IDENTIFICATION	SIZE OF SIGN				T DIMENSIONS NUMBER (INCHES) OF COLOR			POST SIZE UNIT AND AREA	TOTAL AREA		
NUMBER		CHES)	TEXT	LETTER	VERTICAL	OF SIGNS	DACK	BODDED	NUMBER	IN SQUARE	IN SQUARE
	WIDTH	HEIGHT		HEIGHT	SPACING	3.3.13	GROUND LEGEND	BORDER	REQUIRED	FEET	FEET
W10-5	30	30		MU STAI	JTCD NDARD	1	MUTCD STANDAR	RD	P5 (1)	6.25	6.25
W10-5P	24	18	LOW GROUND CLEARANCE			1			MOUNT WITH W10-5	3.00	3.00
W11-1	30	30	\$\forall \tag{\forall}			2			P5 (2)	6.25	12.50
W11-2L	30	30				12			P5 (12)	6.25	75.00
W11-2R	30	30				12			P5 (2)	6.25	12.50
W11-8	30	30				2			P5 (2)	6.25	12.50
W12-2	30	30	12'-11"			2			P5 (2)	6.25	12.50
W13-1P	18	18	<b>25</b> MPH			10			MOUNT WITH W17-1	2.25	22.50
W14-2	30	30	NOOUTLET			1			MOUNT WITH D3-8	6.25	6.25
W16-2A	24	12	250 FT			2			MOUNT WITH W11-8	2.00	4.00
W16-3A	24	12	1 MILE			1			MOUNT WITH W12-2	2.00	2.00
W16-5R	24	18				1			MOUNT WITH W12-2	3.00	3.00
W16-7PL	24	12				12			MOUNT WITH W11-2	2.00	24.00
W16-7PR	24	12				2			MOUNT WITH W11-2R	2.00	4.00
W16-9P	24	12	AHEAD			2			MOUNT WITH W12-2 & R12-5	2.00	4.00
W17-1	30	30	SPEED			10			END P5 (10)	6.25	62.50

SEE MANUAL ON UNIFORM TRAFFIC CONTROL DEVICES 2009 EDITION WITH LATEST REVISIONS AND MASSACHUSETTS AMENDMENTS FOR LATEST SPECIFICATIONS ON TEXT DIMENSIONS AND COLOR.

#### \*25 MPH SPEED LIMIT PER TOWN DIRECTION

THE TOWN OF BARNSTABLE INTENDS TO R&R ALL STREET NAME (D3) SIGNS. ANY SIGNS DEEMED BY THE TOWN TO BE REPLACED WILL BE ADDRESSED OUTSIDE THE SCOPE OF THIS PROJECT.

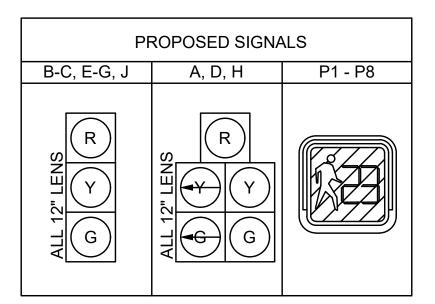
**Environmental Partners** BARNSTABLE, \*
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TRANSPORTATION IMPROVEMENTS ALONG MAIN STREET (ROUTE 6A) AND MILLWAY BARNSTABLE, MASSACHÚSETTS

TRAFFIC SIGN SUMMARY-03

NOT FOR CONSTRUCTION



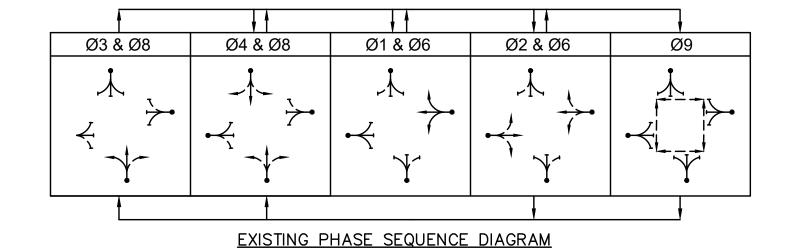
1. ALL INDICATIONS SHALL BE L.E.D. LENSES IN ACCORDANCE WITH THE TECHNICAL SPECIFICATIONS AND EQUIPPED WITH CAP VISORS.

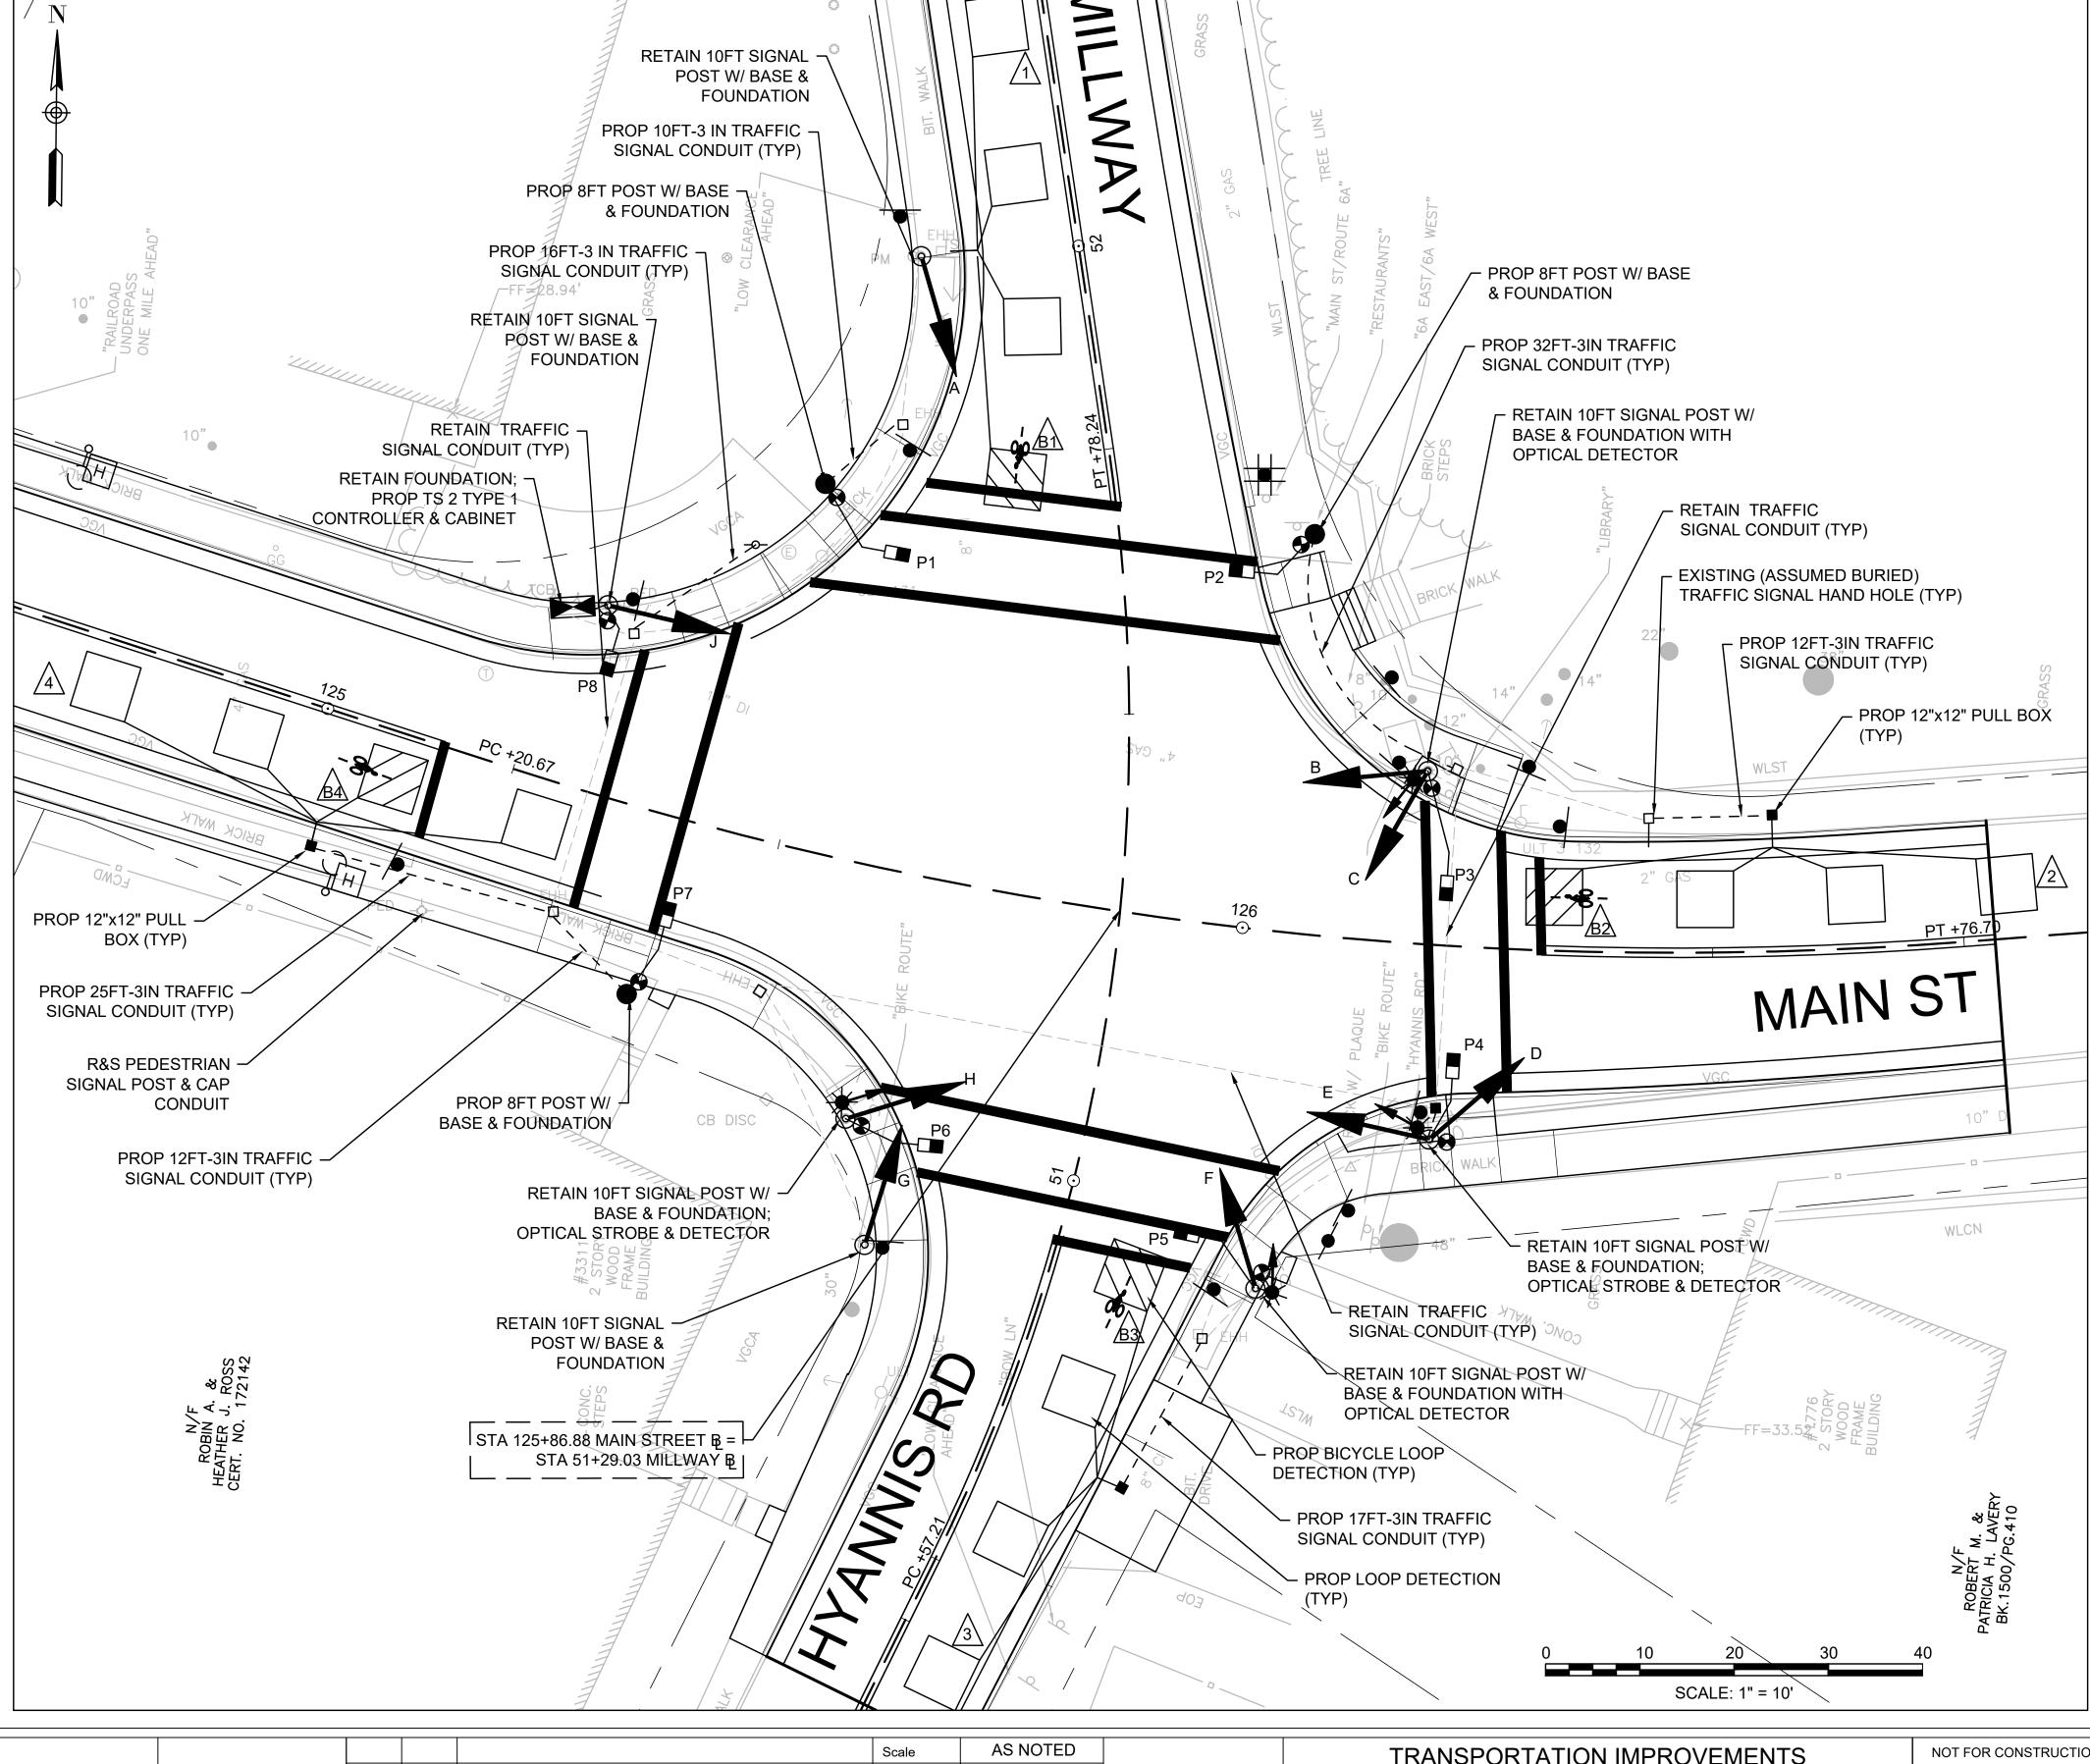
2. ALL PEDESTRIAN INDICATIONS SHALL BE 12" COUNTDOWN L.E.D. AND BE EQUIPPED WITH SUN CAP VISORS.

3. ALL SIGNALS SHALL BE RIGIDLY MOUNTED AND EQUIPPED WITH 5" LOUVERED BACKPLATES WITH REFLECTIVE BORDERS.

#### NOTE

- 1. ALL EXISTING TRAFFIC SIGNAL EQUIPMENT AND CONDUIT IS TO BE RETAINED EXCEPT FOR THE FOLLOWING WHICH ARE TO BE REPLACED: VEHICULAR AND PEDESTRIAN SIGNAL HEADS, PEDESTRIAN PUSH BUTTONS, CONTROLLER AND CONTROLLER CABINETS, ONE SIGNAL POST, AND EMERGENCY PRE-EMPTION EQUIPMENT.
- 2. ALL EXISTING TRAFFIC SIGNAL POSTS AND BASES SHALL BE REFINISHED INCLUDING SANDED AND REPAINTED AS SPECIFIED.
- 3. ADDITIONAL PEDESTRIAN POSTS ARE PROPOSED TO PROVIDE ADA/MUTCD COMPLIANT A.P.S. PEDESTRIAN ACCOMMODATIONS. NEW LOOP DETECTION IS TO BE PROVIDED.
- 4. ANY WIRING REQUIRED TO ACHIEVE AN OPERATING SYSTEM SHOWN ON PLAN OR SPECIFIED IS CONSIDERED INCIDENTAL TO THE PROJECT.







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TRANSPORTATION IMPROVEMENTS ALONG MAIN STREET (ROUTE 6A) AND MILLWAY BARNSTABLE, MASSACHUSETTS

TRAFFIC SIGNAL PLAN - 01

NOT FOR CONSTRUCTION
Sheet No.

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\* MAX 2 TO OPERATE MONDAY THRU FRIDAY 3-7PM

MAX 1 TO OPERATE ALL OTHER TIMES

#### TRAFFIC SIGNAL AND PHASING NOTES

- 1. ANY SERIES OR COMBINATION OF PHASES MAY BE SKIPPED
- 2. IF THE ASSIGNED RIGHT-OF-WAY FOR ANY TRAFFIC MOVEMENT IS TO REMAIN IN EFFECT DURING THE NEXT CALLED PHASE THE SIGNAL INDICATIONS FOR THAT MOVEMENT WILL NOT CHANGE DURING THE CLEARANCE INTERVAL.
- 3. IF THE ASSIGNED RIGHT-OF-WAY FOR ANY TRAFFIC MOVEMENT IS TO CHANGE DURING THE NEXT CALLED PHASE THE SIGNAL INDICATION FOR THAT TRAFFIC MOVEMENT WILL DISPLAY THE APPROPRIATE CLEARANCE INTERVAL.

	LOOP DETECTOR DATA								
DET. ID.	NO. SECTIONS SIZE	NO. OF TURNS	CALL DELAY	CALL PHASE	EXTEND PHASE	OPERATION	LOOP CONNECTION		
1	3-6' x 6'	3	0	4	_	PRESENCE	SERIES		
B1	1 - BICYCLE	*	0	4	-	PRESENCE	_		
2	3-6' x 6'	3	0	1	_	PRESENCE	SERIES		
B2	1 - BICYCLE	*	0	1	_	PRESENCE	_		
$\sqrt{3}$	3-6' x 6'	3	0	3	_	PRESENCE	SERIES		
<u>B3</u>	1 - BICYCLE	*	0	3	1	PRESENCE	_		
4	3-6' x 6'	3	0	2	_	PRESENCE	SERIES		
B4	1 - BICYCLE	*	0	2	_	PRESENCE	_		

\* SEE STANDARD BICYCLE LOOP DETECTOR DETAILS

PRE-EMPTION PHASING & PRIORITY								
DETECTOR & PRIORITY	PRE-EMPT PHASE ASSIGNMENT	MOVEMENT	VEHICLE PHASE ASSIGNMENT					
D1	1	+	Ø2					
D2	2	<del>\</del>	Ø1					
D3	3		Ø3					
D4	4	<b>\</b>	Ø4					

EMERGENCY VEHICLE PRE-EMPTION SIGNALS SHALL BE OPTICALLY TRANSMITTED BY OPTICAL EMITTERS MOUNTED IN EMERGENCY VEHICLES AND RECEIVED BY OPTICAL DETECTORS LOCATED AT THE INTERSECTION.

PRE-EMPTION SIGNALS SHALL BE SERVICED ON A PRIORITY BASIS WITH DETECTORS 1, 2, 3 OR 4 ASSIGNED DESCENDING PRIORITIES AS FOLLOWS: (1 HIGHEST AND 4 LOWEST)

IN RESPONSE TO A PRE-EMPTION SIGNAL RECEIVED AT AN INTERSECTION BY OPTICAL DETECTOR D1 (OR D2, D3, D4) THE CONTROLLER SHALL HOLD OR ADVANCE TO AND HOLD IN EMERGENCY VEHICLE PRE-EMPTION PHASE #1 (OR #2, #3, #4) GREEN FOR A MINIMUM OF TEN (10) SECONDS OR UNTIL PRE-EMPTION SIGNAL CEASES. THE CONTROLLER SHALL THEN TIME PRE-EMPTION PHASE CLEARANCE (3 SECONDS: YELLOW AND 2 SECONDS ALL RED) AND SERVICE EMERGENCY VEHICLE PRE-EMPTION PHASE #2 (OR #1) IF NECESSARY, THEN TIME PHASE PRE-EMPTION CLEARANCE AND RESUME NORMAL SIGNAL OPERATION. EMERGENCY VEHICLE PRE-EMPTION PHASE #3 AND #4 SHALL BE SIMILARLY SERVED.

MINIMUM GREEN, NORMAL VEHICLE CLEARANCE, SHALL BE PROVIDED ON PHASES THAT ARE TO BE TERMINATED BY PRE-EMPTION DEMAND.

OPTICOM STROBE SHALL BE ILLUMINATED WHENEVER ANY EMERGENCY VEHICLE PRE-EMPTION GREEN IS ON.

#### ITEM 816.01

	TRAFFIC CONTROL SIGNALS MAJOR ITEMS REQUIRED
QUAN.	ITEM
1	R&S ONE EXISTING TRAFFIC SIGNAL POST AND CAP CONDUIT; REMOVE AND DISPOSE OF FOUNDATION;
1	R&S VEHICULAR AND PEDESTRIAN SIGNAL HEADS, PEDESTRIAN PUSH BUTTONS, CONTROLLER, AND EXISTING EMERGENCY PRE-EMPTION EQUIPMENT AS REQUIRED
3	8' ORNAMENTAL SIGNAL POST, BASE & FOUNDATION
7	PREPARE, REFINISH, SAND AND RE-PAINT EXISTING T.S. POSTS AND BASES AS SPECIFIED
3	SIGNAL HEAD-1 WAY-3 SECTION-12" L.E.D. SIGNAL LENSES
2	SIGNAL HEAD-1 WAY-5 SECTION-12" L.E.D. SIGNAL LENSES
1	SIGNAL HEAD-2 WAY- 3 SECTION/5 SECTION-12"
	LED SIGNAL LENSES
1	SIGNAL HEAD-2 WAY- 3 SECTION-12" LED SIGNAL LENSES
8	COUNTDOWN PEDESTRIAN SIGNAL HEAD
16	WIRE LOOP DETECTORS INCLUDING ALL LEAD-IN WIRES AND WIRING AS REQ'D
2	DUAL CHANNEL LOOP DETECTOR AMPLIFIERS
8	PEDESTRIAN AUDIBLE & VIBRO-TACTILE PUSH BUTTON, SIGN & SADDLE WITH LED CONFIRMATION
9	5" LOUVERED BACKPLATES WITH REFLECTIVE BORDERS
4	12"x12" PULL BOX - SD2.031 (ITEM 811.31)
1	SERVICE CONNECTION (OVERHEAD) (ITEM 813.80)
1	TS2 CONTROLLER IN BASE MOUNTED TS2 TYPE 1 8-PHASE CABINET MOUNTED ON EXISTING FOUNDATION
1	MALFUNCTION MANAGEMENT UNIT
1	BATTERY BACK UP SYSTEM

PLUS ALL MISC. EQUIPMENT, CABLE WIRING AND INCIDENTALS NECESSARY TO PROVIDE A COMPLETE OPERATING TRAFFIC CONTROL SIGNAL (SEE SPECIAL PROVISIONS FOR COMPLETE EQUIPMENT REQUIRED).

#### ITEM 816.01

EMERGENCY VEHICLE PRIORITY CONTROL SYSTEM LIST OF MAJOR ITEMS REQUIRED								
QUAN.	DESCRIPTION							
1	OPTICOM 4-CHANNEL PHASE SELECTOR KIT (OPTICOM MODEL 754)							
2	CONFIRMATION WHITE STROBE LIGHT							
4	OPTICAL DETECTOR (UNIDIRECTIONAL) (OPTICOM MODEL 711) WITH EXTENDER ARMS AS REQUIRED							

PLUS ALL MISCELLANEOUS EQUIPMENT, CABLE AND INCIDENTAL MATERIAL NECESSARY TO PROVIDE A COMPLETE OPERATING CONTROL SYSTEM (SEE SPECIAL PROVISIONS FOR COMPLETE **EQUIPMENT REQUIRED.)** 

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P		
	1	

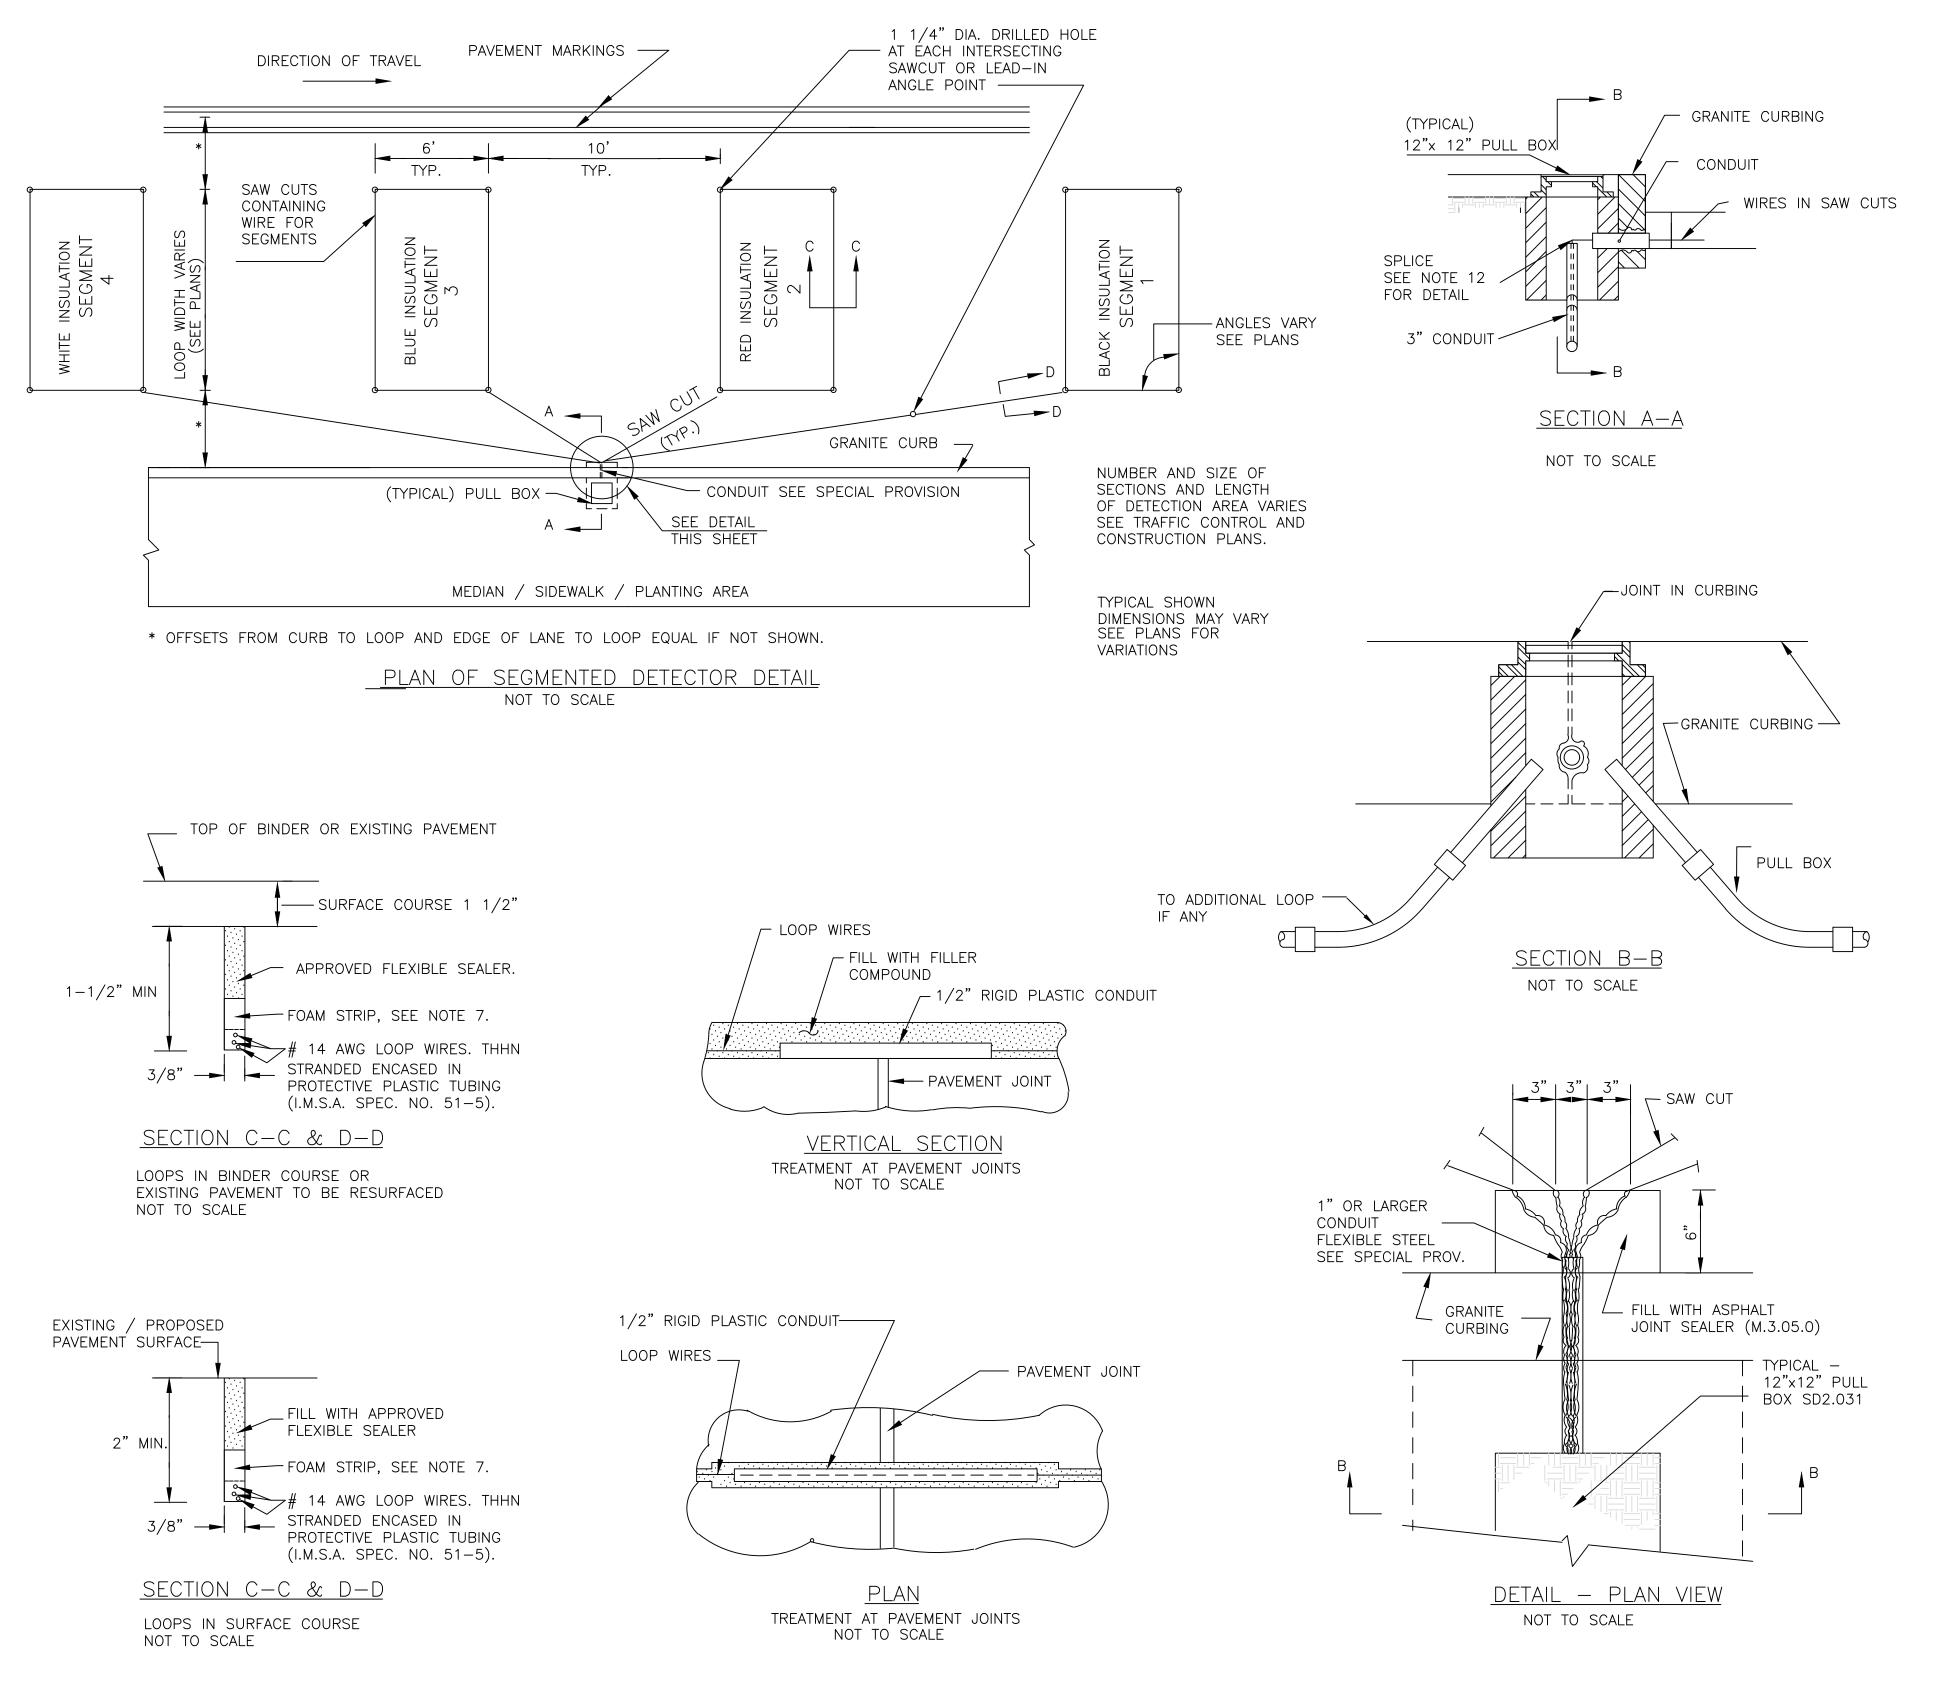
TRAFFIC SIGNAL PLAN - 02

NOT FOR CONSTRUCTION

Sheet No.

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BARNSTABLE,



#### <u>DETECTOR NOTES</u>

- 1. IN HANDHOLE, SPLICE ALL SEGMENTS TO TYPE II—SHIELDED LOOP DETECTOR DETECTOR LEAD—IN CABLE. SEGMENTS SHALL BE SPLICED IN PARALLEL, IN SERIES, OR IN A COMBINATION OF PARALLEL & SERIES AS SHOWN ON THE PLAN SHEET FOR EACH DETECTOR. NUMBER OF TURNS OF WIRE SHALL ALSO BE AS SHOWN ON THE PLAN SHEET FOR EACH DETECTOR. SEE NOTE 12.
- 2. SEE SPECIAL PROVISIONS FOR REQUIREMENTS OF DETECTOR AMPLIFIER.
- 3. LEAD IN WIRES SHALL BE TWISTED FROM SEGMENT TO SPLICE WITH SHIELDED CABLE FIVE TURNS PER FOOT. LEAD—IN SHALL BE TYPE II (M8. 16. II).
- 4. BEFORE STARTING ANY SPLICING, THE ELECTRICAL CONTRACTOR SHALL FURNISH DATA SHEETS ON THE MATERIALS AND/OR METHODS TO BE USED IN ACCORDANCE WITH THE DEPARTMENTS STANDARD OPERATING PROCEDURES FOR APPROVAL OF SHOP DRAWINGS SEE SECTION 815.64, ESPECIALLY PARAGRAPH 1.
- 5. THE METALLIC SHIELD WHICH SHALL ENCASE THE DETECTOR LEADS FROM A SPLICE (TYPICALLY LOCATED IN A PULL BOX NEAR THE ROADWAY COMPONENT OF THE DETECTOR) THE METALLIC SHIELD WHICH SHALL INCASE THE DETECTOR LEADS FROM A SPLICE (TYPICALLY LOCATED IN A PULL BOX NEAR THE ROADWAY COMPONENT OF THE DETECTOR) OT THE CONTROLLER, AND THE DRAIN WIRE UNDER THE METALLIC SHIELD, SHALL NOT BE GROUNDED TO THE EARTH GROUNDING BUSS IN THE CONTROLLER, AND THE SHIELD AND DRAIN WIRE SHALL BE CAREFULLY INSULATED FROM THE TRANSFORMER NEUTRAL TO CONTROL CABINET, OR FROM EARTH GROUND AT ALL POINTS ALONG IT'S LENGTH. SPECIFICALLY, THIS INCLUDES CAREFUL INSULATION OF THE EXPOSED PORTION OF THE SHIELD AND THE AND THE DRAIN WIRE AT THE END AWAY FROM THE CONTROLLER WHERE IT IS SPLICED TO WIRES LEADING TO THE ROADWAY COMPONENT OF THE DETECTOR. THIS IS IMPORTANT TO AVOID A GROUND RETURN LOOP.
- 6. FILL ALL CONDUIT OPENINGS WITH DUCT SEAL.
- 7. AFTER SAW CUTS ARE COMPLETE, BLOW OUT WATER WITH OIL FREE COMPRESSED AIR UNTIL CUTS ARE CLEAN AND DRY. INSERT WIRE INTO CLEAN SLOT WITH A BLUNT, SMOOTH, ROUND EDGED TOOL OF WOOD OR PLASTIC SUCH AS A PAINT STIRRER. DO NOT USE A SCREWDRIVER, THEN INSERT FOAM PLASTIC HOLD DOWN STRIPS, SIMILAR TO ETHA FOAM SB STRIPS SHALL BE ABOUT 2" LONG, PLACED IN THE SLOT ABOUT EVERY 2 FEET. THEN POUR SEALER, TAKING CARE TO ELIMINATE BUBBLES.
- 8. THE COMBINED ROADWAY LOOP, TWISTED LEAD—IN WIRES, SPLICE AND SHIELDED LEAD—IN CABLE SHALL HAVE A RESISTANCE TO GROUND OF AT LEAST 100 MEGOHMS. SEE SPECIAL PROVISIONS FOR ADDITIONAL REQUIREMENTS.
- 9. FOR INSTALLATION OF SINGLE (ONE SEGMENT) SMALL WIRE LOOP DETECTOR DETAIL IS THE SAME
- 10. CUT LOOPS IN BINDER AND FILL WITH APPROVED FLEXIBLE SEALER.
- 11. DETECTOR WIRE SHALL BE A DIFFERENT COLOR FOR EACH SEGMENT OF A DETECTOR GROUP. SEE DETAIL
- 12. SPLICING PATTERN P = SERIES/PARALLEL: SPLICE SEGMENTS 1 AND 3 OF AN 12. INDIVIDUAL DETECTOR IN SERIES. SPLICE SEGMENTS 2 AND 4 IN SERIES. SPLICE THE RESULTANT TWO GROUPS IN PARALLEL. SPLICE THE RESULTANT COMBINATION TO ONE LEAD—IN CABLE. CONNECT THIS CABLE TO AN OTHERWISE UNUSED AMPLIFIER CHANNEL. SPLICING PATTERN S = SERIES: SPLICE ALL SEGMENTS (TYPICALLY FOUR, BUT MAY BE LESS) OF AN INDIVIDUAL DETECTOR IN SERIES. SPLICE THE RESULTANT COMBINATION TO ONE LEAD—IN CABLE TO AN OTHERWISE UNUSED AMPLIFIER CHANNEL.



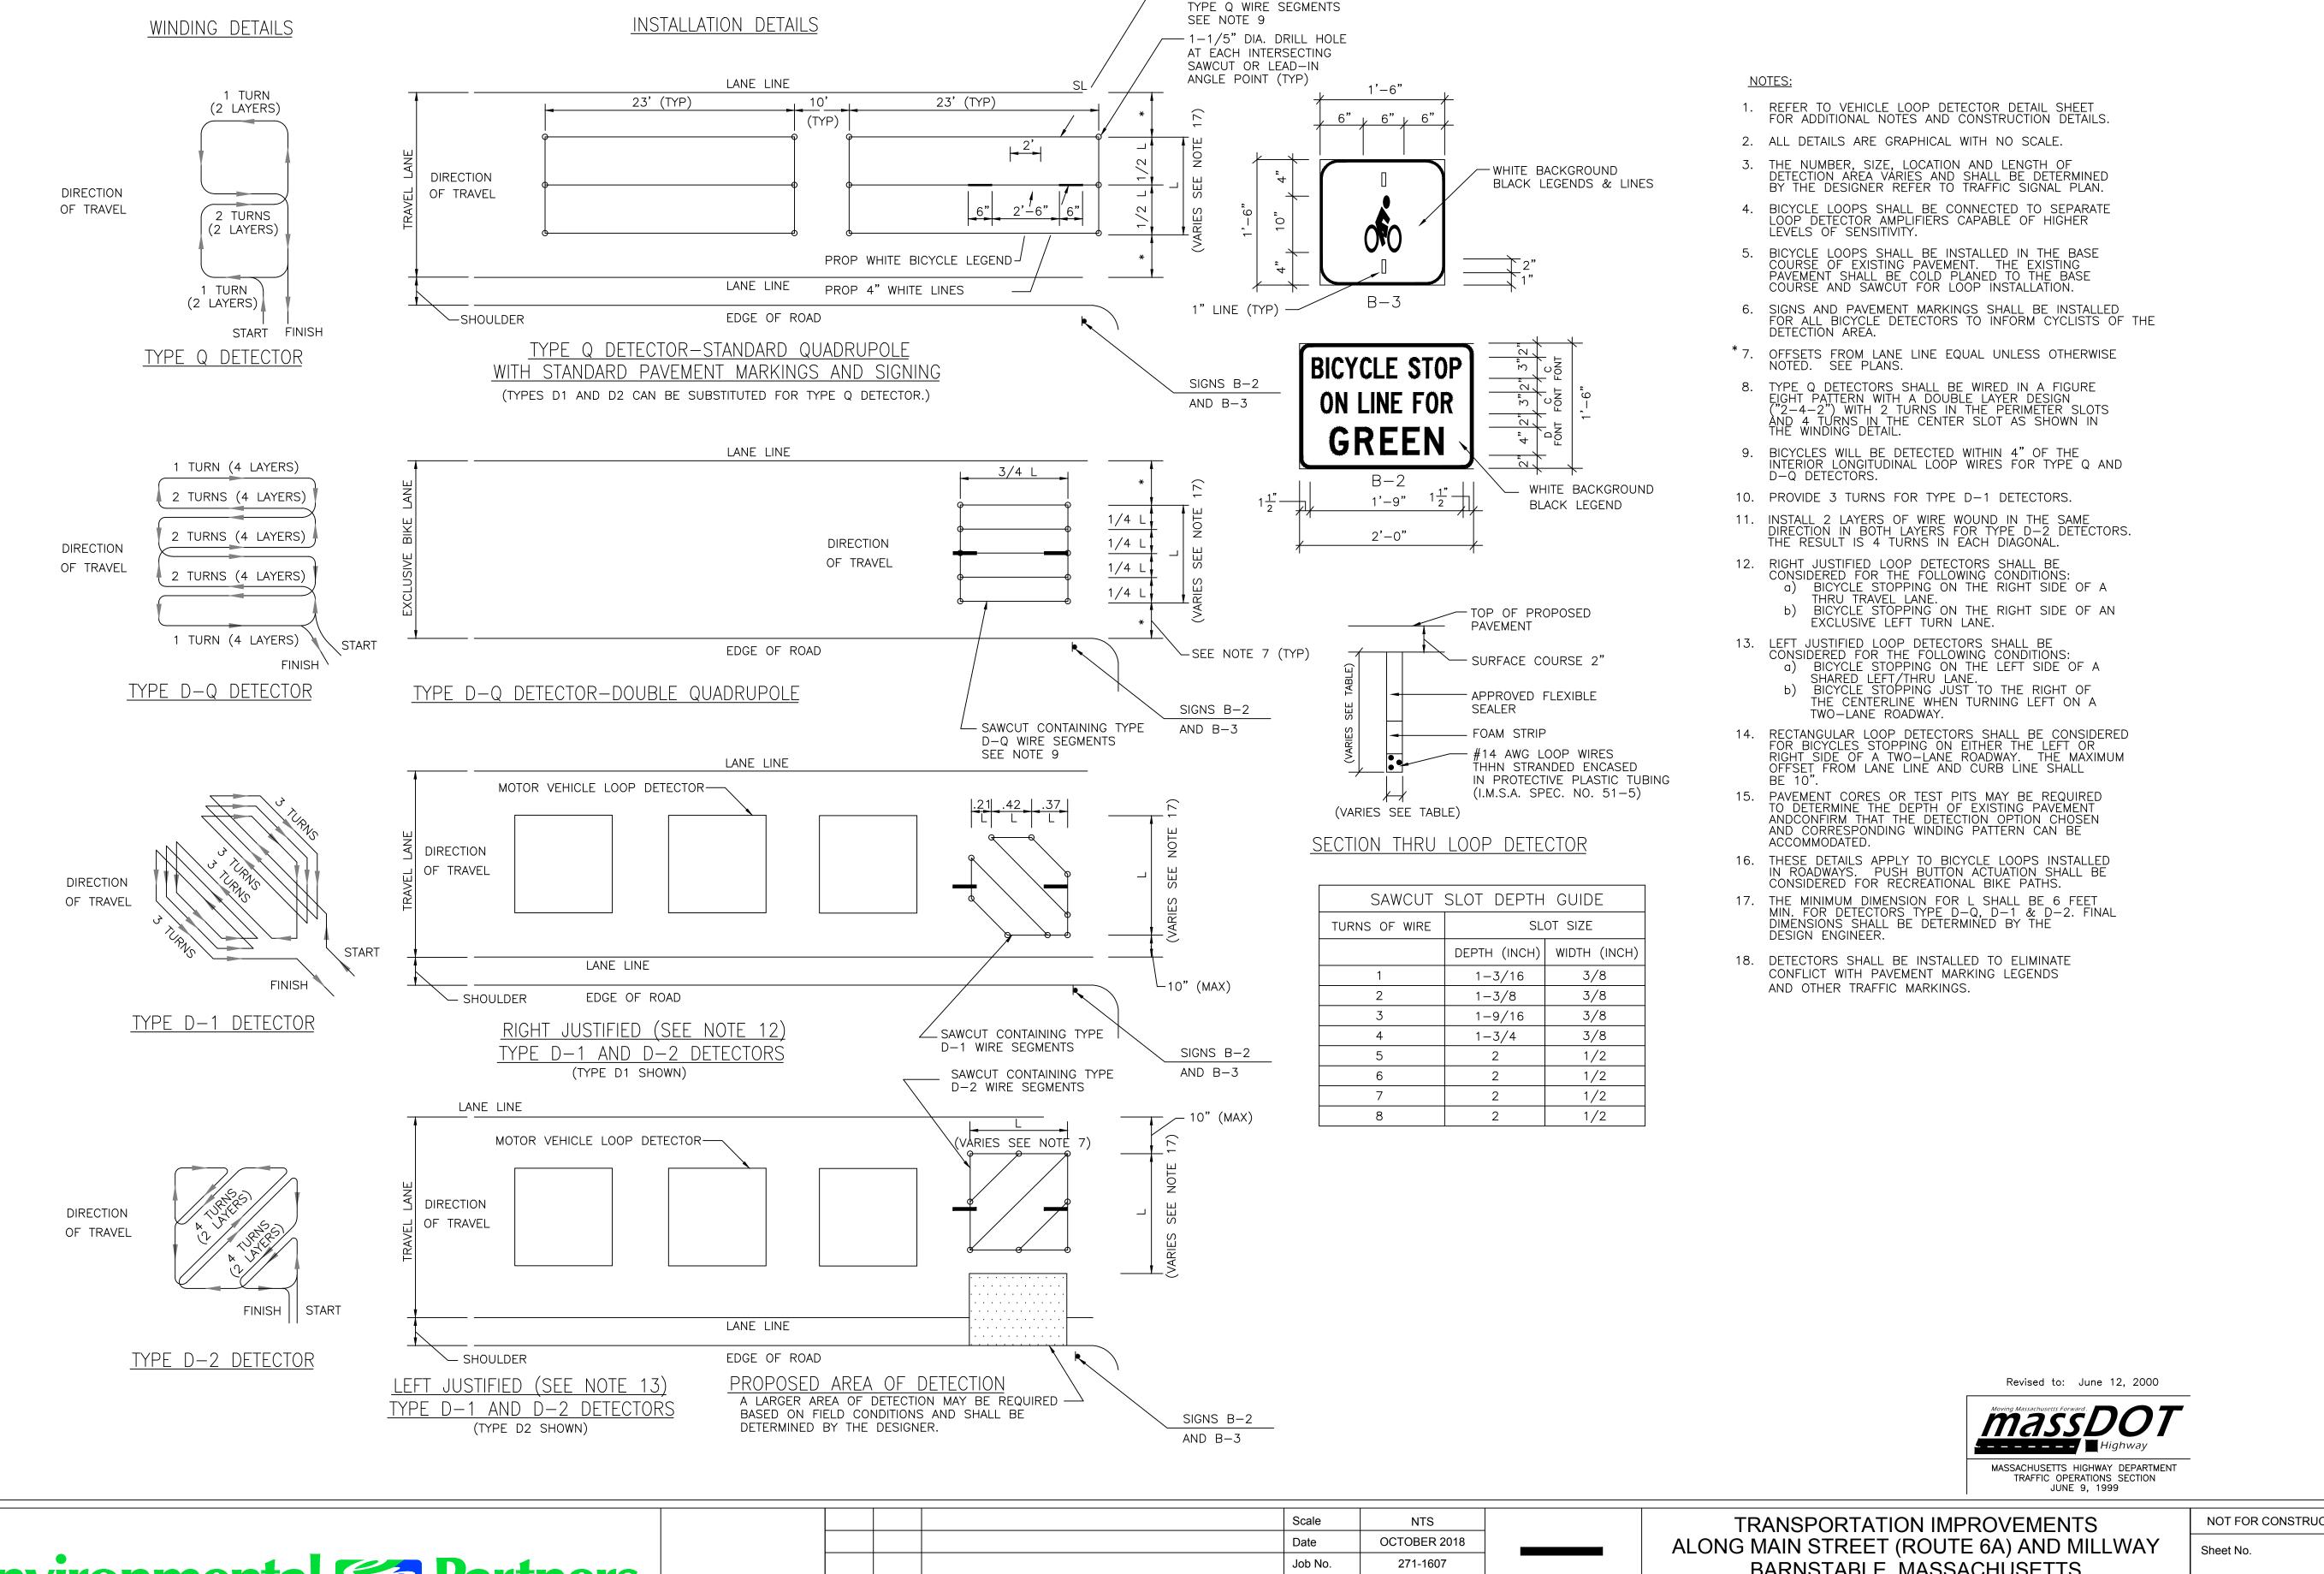
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TRANSPORTATION IMPROVEMENTS ALONG MAIN STREET (ROUTE 6A) AND MILLWAY BARNSTABLE, MASSACHUSETTS

TRAFFIC SIGNAL DETAILS - 01

NOT FOR CONSTRUCTION

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- SAWCUT CONTAINING

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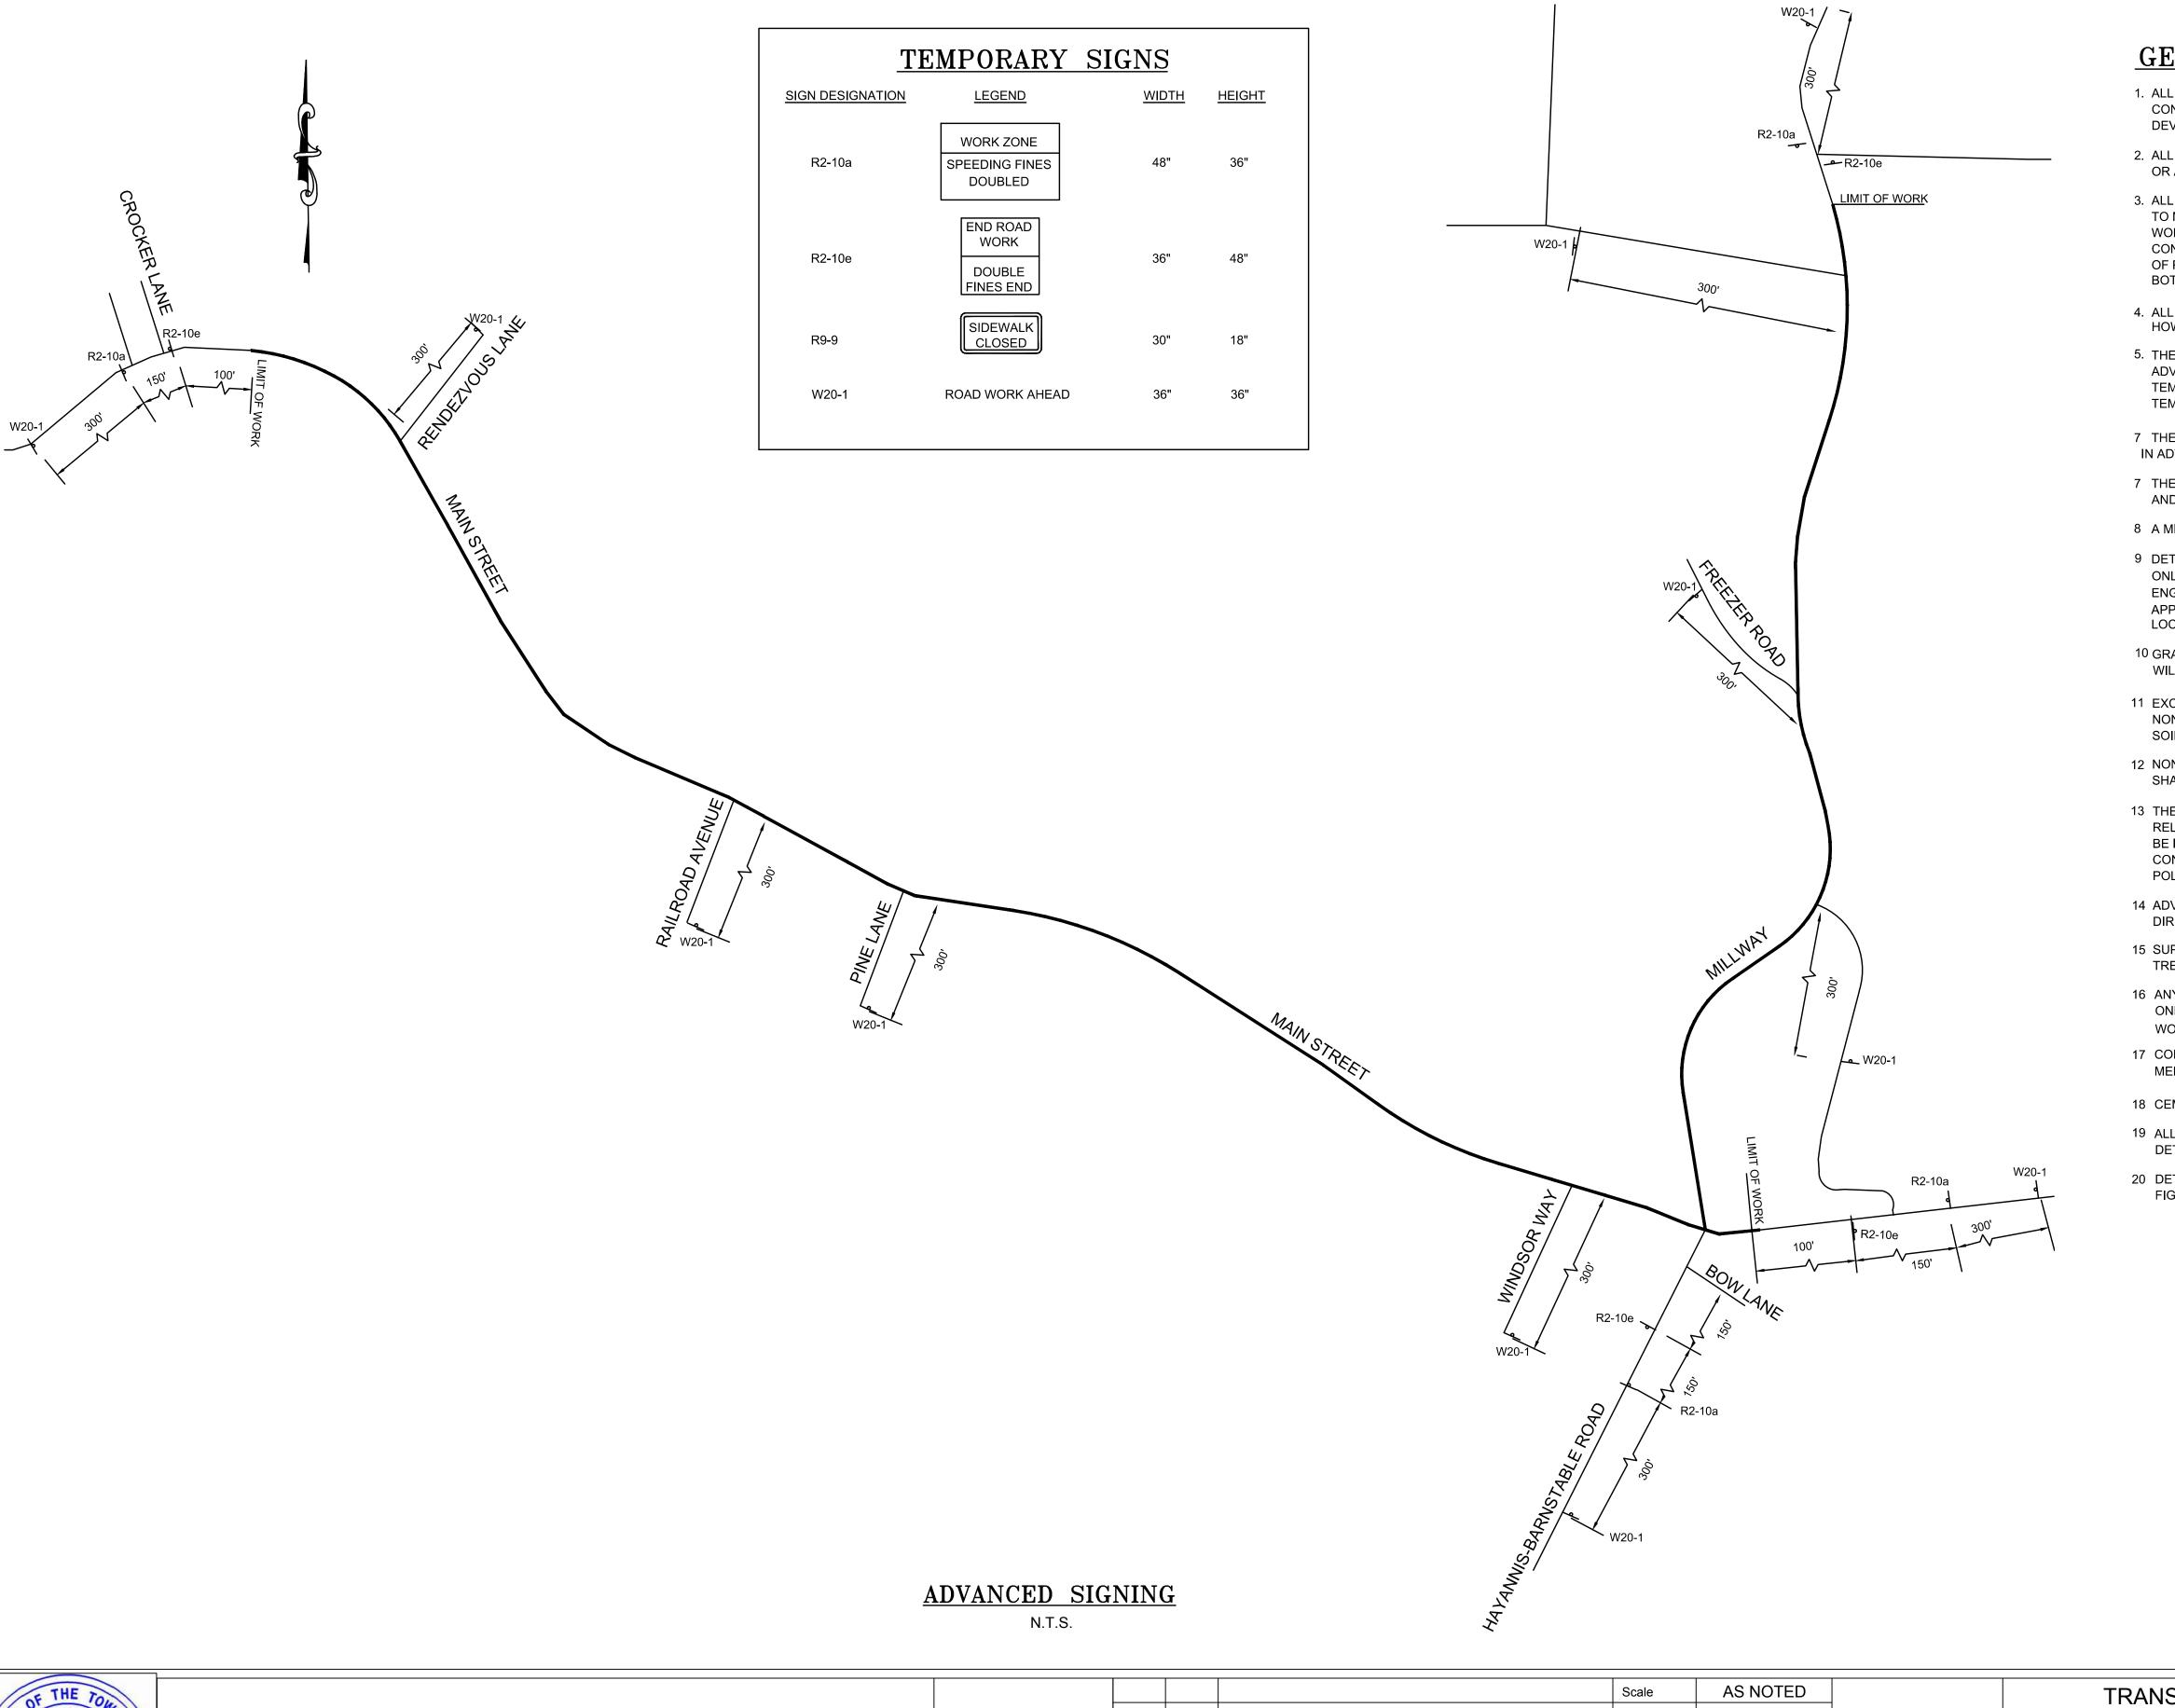
BARNSTABLE, MASS.

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BARNSTABLE, MASSACHUSETTS

TRAFFIC SIGNAL DETAILS - 02

NOT FOR CONSTRUCTION



### GENERAL NOTES

- 1. ALL CONSTRUCTION SIGNING, DRUMS, BARRICADES AND OTHER DEVICES SHALL CONFORM WITH PART 6 OF THE LATEST EDITION MANUAL ON UNIFORM TRAFFIC CONTROL DEVICES (M.U.T.C.D.)
- 2. ALL CHANNELIZING DEVICES SHALL BE SET @ 25' O.C. MAX. UNLESS OTHERWISE NOTED OR ADJUSTED BY THE RESIDENT ENGINEER.
- 3. ALL DRUMS SHALL BE APPROPRIATELY PLACED AND MOVED AS NECESSARY TO MAINTAIN ADEQUATE ABUTTER ACCESS AT ALL TIMES. WORK MAY REQUIRE ADDITIONAL SIGNS, DRUMS AND OTHER TRAFFIC CONTROL DEVICES, GRADING AND TEMPORARY PAVEMENT FOR PASSAGE OF PEDESTRIAN, VEHICULAR AND EMERGENCY TRAFFIC THROUGH THE WORK AREAS, BOTH DURING AND AFTER WORK HOURS, TO MAINTAIN SUCH ACCESS.
- 4. ALL DISTANCE MAY BE ADJUSTED TO FIT FIELD CONDITIONS, AS DIRECTED BY THE TOWN. HOWEVER MINIMUM DISTANCES, WHERE INDICATED SHALL BE MAINTAINED.
- 5. THE CONTRACTOR SHALL NOTIFY EACH ABUTTER AT LEAST 24 HOURS IN ADVANCE OF THE START OF ANY WORK THAT WILL REQUIRE THE TEMPORARY CLOSURE OF ACCESS, SUCH AS EXISTING PAVEMENT EXCAVATION, TEMPORARY DRIVEWAY PAVEMENT PLACEMENT AND SIMILAR OPERATIONS.
- 7 THE CONTRACTOR WILL NOTIFY BUSINESSES AND THE TOWN AT LEAST 24 HRS IN ADVANCE OF IMPACTED ON STREET PARKING CLOSURES
- 7 THE CONTRACTOR SHALL NOTIFY THE TOWN OF BARNSTABLE POLICE, FIRE, AND DEPARTMENT OF PUBLIC WORKS AT LEAST 48 HOURS IN ADVANCE OF LANE CLOSURES.
- 8 A MINIMUM OF ONE LANE OF TRAFFIC IN EACH DIRECTION SHALL BE MAINTAINED AT ALL TIMES.
- 9 DETOURS MAY ONLY BE CONSIDERED FOR TRAVELWAY SURFACE RESTORATION WORK ONLY (I.E. PAVEMENT COLD PLANE AND RESURFACING) AT THE APPROVAL OF THE RESIDENT ENGINEER. EXCEPTIONS MAY BE MADE FOR MAJOR INTERSECTION WORK, BUT MUST BE APPROVED IN WRITING BY THE RESIDENT ENGINEER AND COORDINATED WITH THE APPROPRIATE LOCAL AUTHORITIES.
- 10 GRADE SEPARATIONS IN EXCESS OF 2 INCHES DURING NON-WORKING HOURS WILL REQUIRE DELINEATION BY USE OF DRUMS.
- 11 EXCAVATION EDGES IN EXCESS OF 4 INCHES DEEP SHALL BE PROTECTED DURING NON-WORKING HOURS BY BACKFILLING WITH A WEDGE OF GRAVEL OR SOIL COMPACTED TO A 4:1 SLOPE.
- 12 NONESSENTIAL TEMPORARY CONSTRUCTION TRAFFIC CONTROL DEVICES SHALL BE COVERED OR REMOVED DURING NON-WORKING HOURS.
- 13 THE GENERAL SEQUENCE OF WORK IS DEPENDENT UPON THE REMOVAL AND RELOCATION OF THE EXISTING UTILITY POLES AND WIRES THAT ARE FOUND TO BE IN CONFLICT WITH THE PROPOSED WORK, BY THE UTILITY COMPANIES. THE CONTRACTOR SHALL SCHEDULE THE WORK IN EACH AREA TO COORDINATE WITH THE POLE RELOCATION WORK.
- 14 ADVISORY SPEED PLATES (W13-1) SHALL BE USED IF APPROPRIATE AND AS DIRECTED BY THE ENGINEER.
- 15 SUPPORTS FOR ALL TRAFFIC MANAGEMENT SIGNS SHALL BE 4" X 4" PRESSURE TREATED WOOD POSTS.
- 16 ANY LANE CLOUSURE WORK MUST BE PERFORMED BETWEEN THE HOURS OF 7:00 AM 3:30 PM ONLY, EXCEPTION FOR A SHORT PERIOD OF TIME AS APPROVED BY THE CITY. WORKING BEYOND THESE HOURS OR OVER THE WEEKEND MUST BE APPROVED BY THE TOWN.
- 17 CONSTRUCTION SHALL NOT TAKE PLACE DURING THE SUMMER MONTHS (BETWEEN MEMORIAL DAY AND LABOR DAY).
- 18 CEMENT CONCRETE BARRIERS TO BE USED AS NEEDED AND DIRECTED BY THE TOWN.
- 19 ALL TEMPORARY TRAFFIC CONTROL WORK FOR SIDEWALK CLOSURE AND PEDESTRIAN DETOUR SHALL CONFORM TO THE LATEST EDITION OF THE MASSDOT STANDARD
- 20 DETAILS AND DRAWINGS FOR THE DEVELOPMENT OF TEMPORARY TRAFFIC CONTROL PLANS FIGURE PED-1 TO FIGURE PED-7.

## **LEGEND**

CHANNELIZING DEVICE PROPOSED TRAFFIC FLOW **WORK ZONE** TYPE III BARICADE POLICE DETAIL **FLAGGER** CONSTRUCTION SIGN NOT TO SCALE N.T.S.



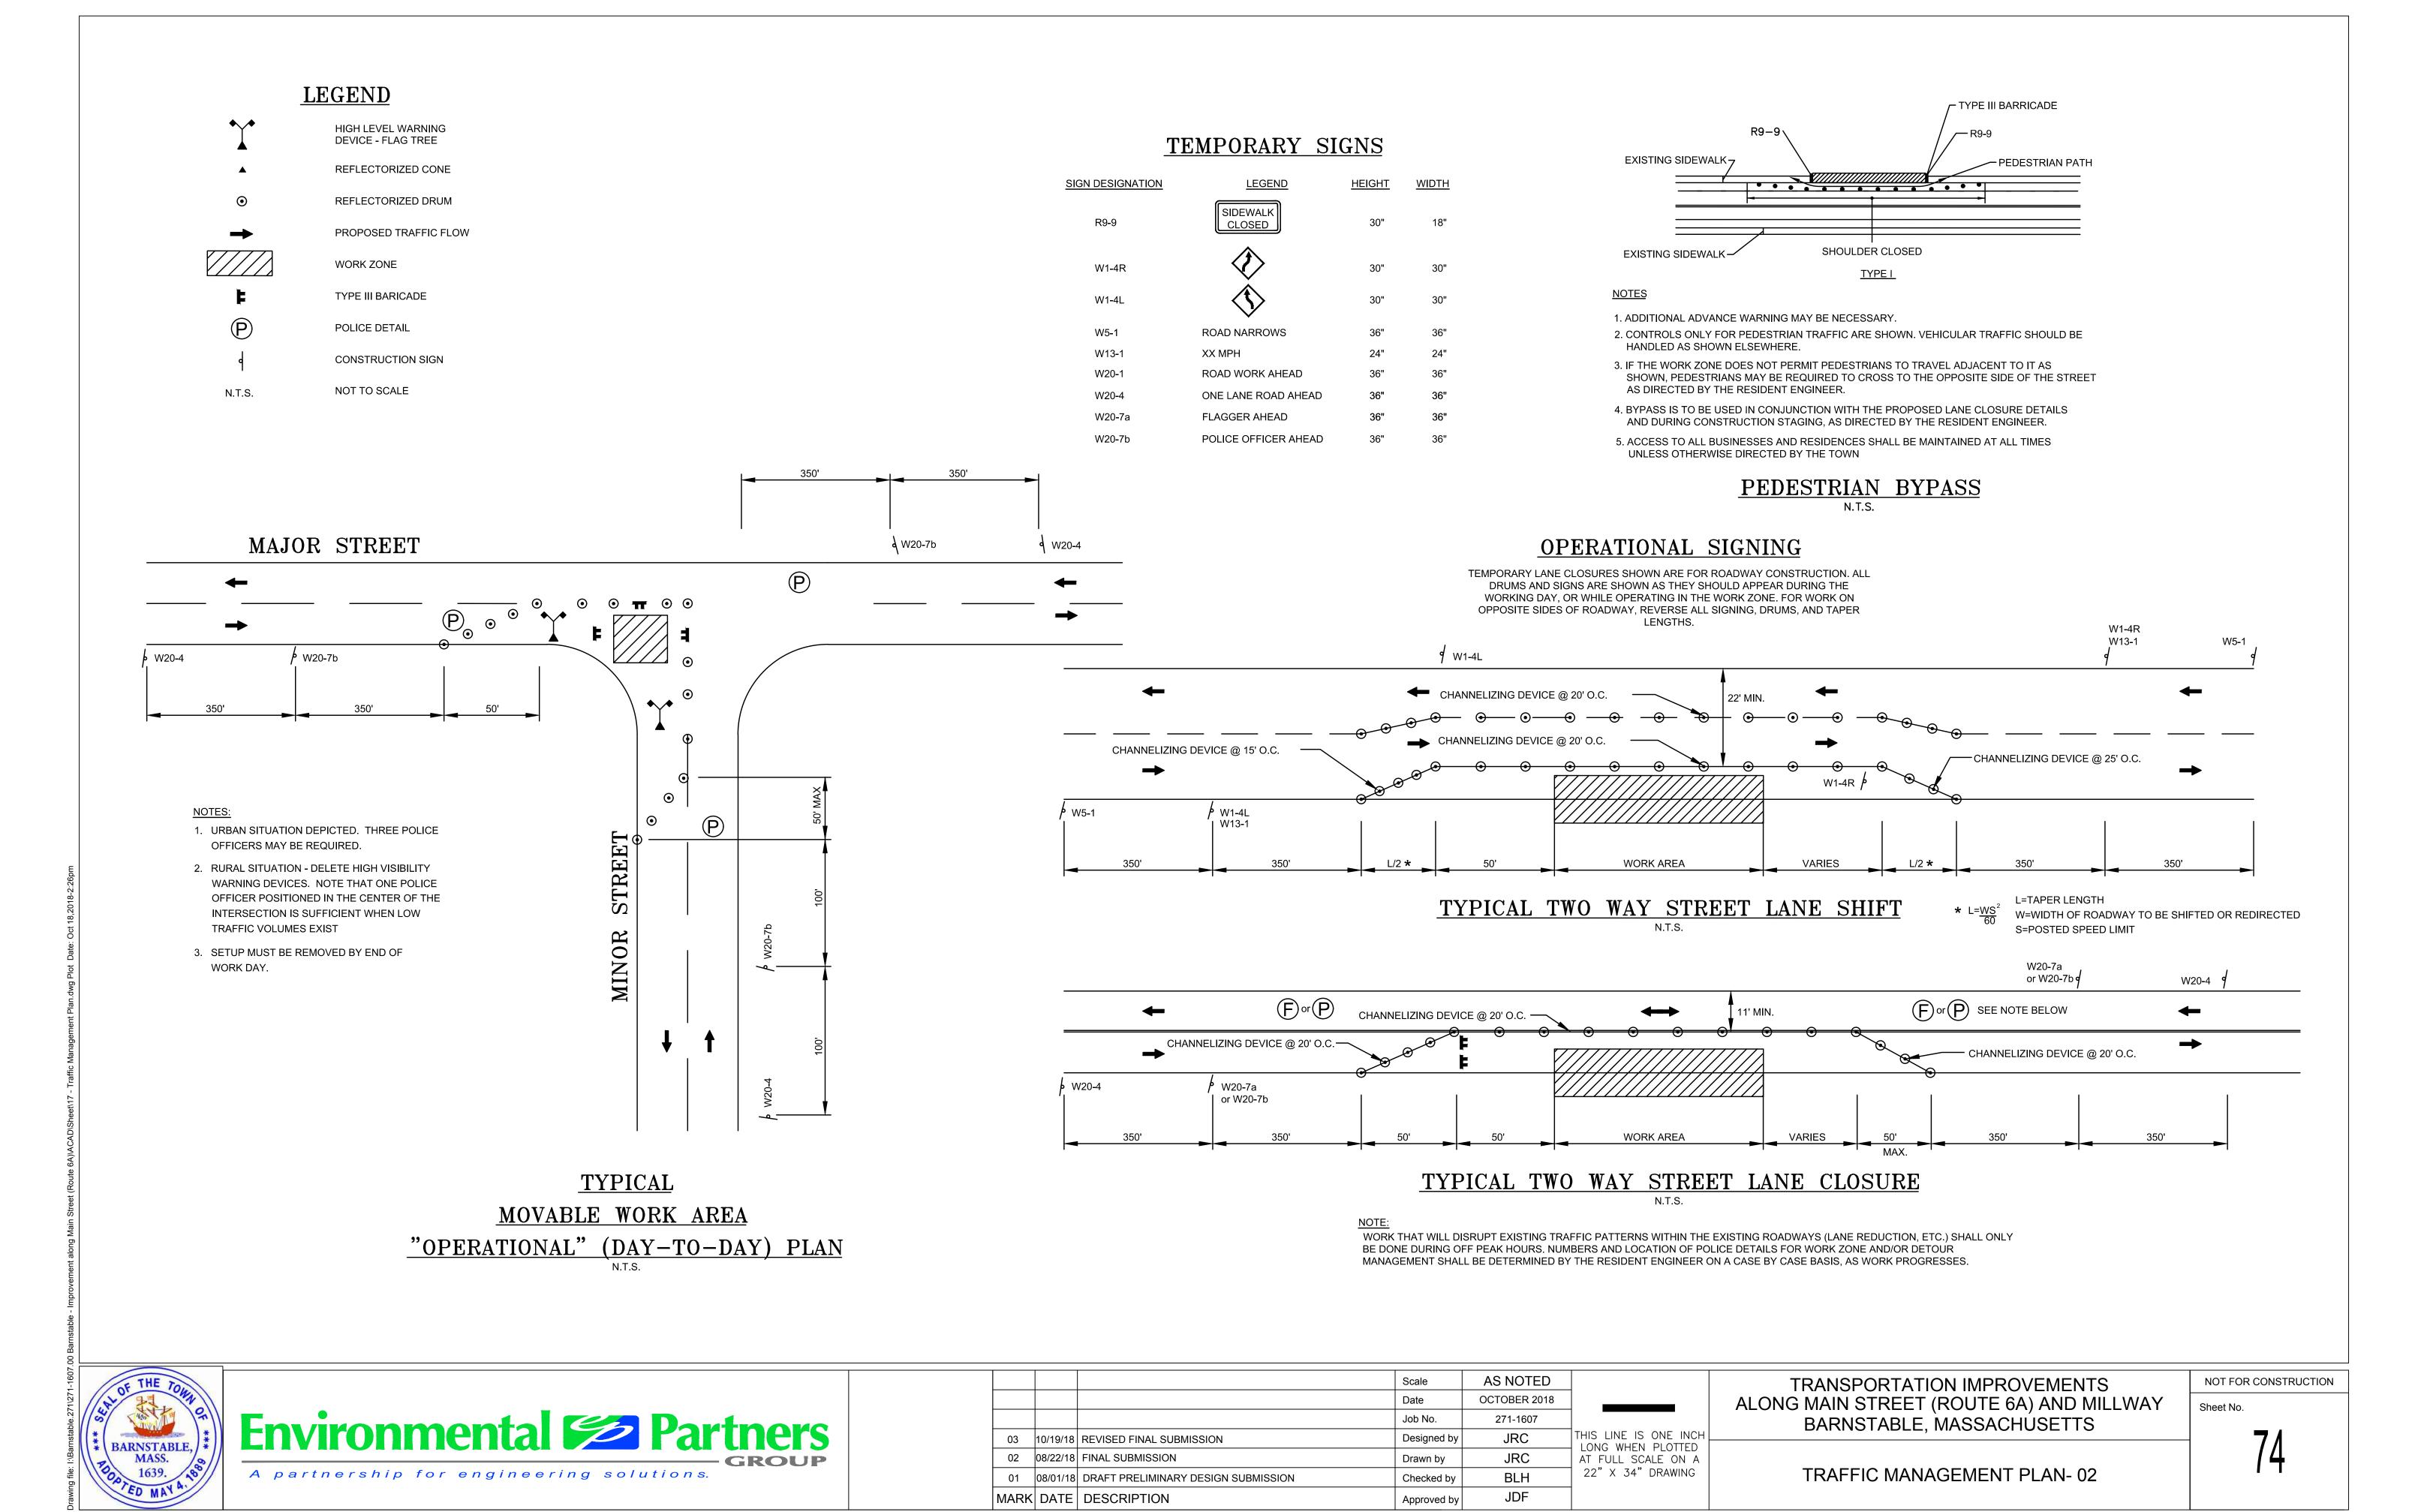
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			Date	OCTOBER 2018	
			Job No.	271-1607	
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02	08/22/18	FINAL SUBMISSION	Drawn by	JRC	AT FULL SCALE ON A
01	08/01/18	DRAFT PRELIMINARY DESIGN SUBMISSION	Checked by	BLH	22" X 34" DRAWING
MAR	K DATE	DESCRIPTION	Approved by	JDF	

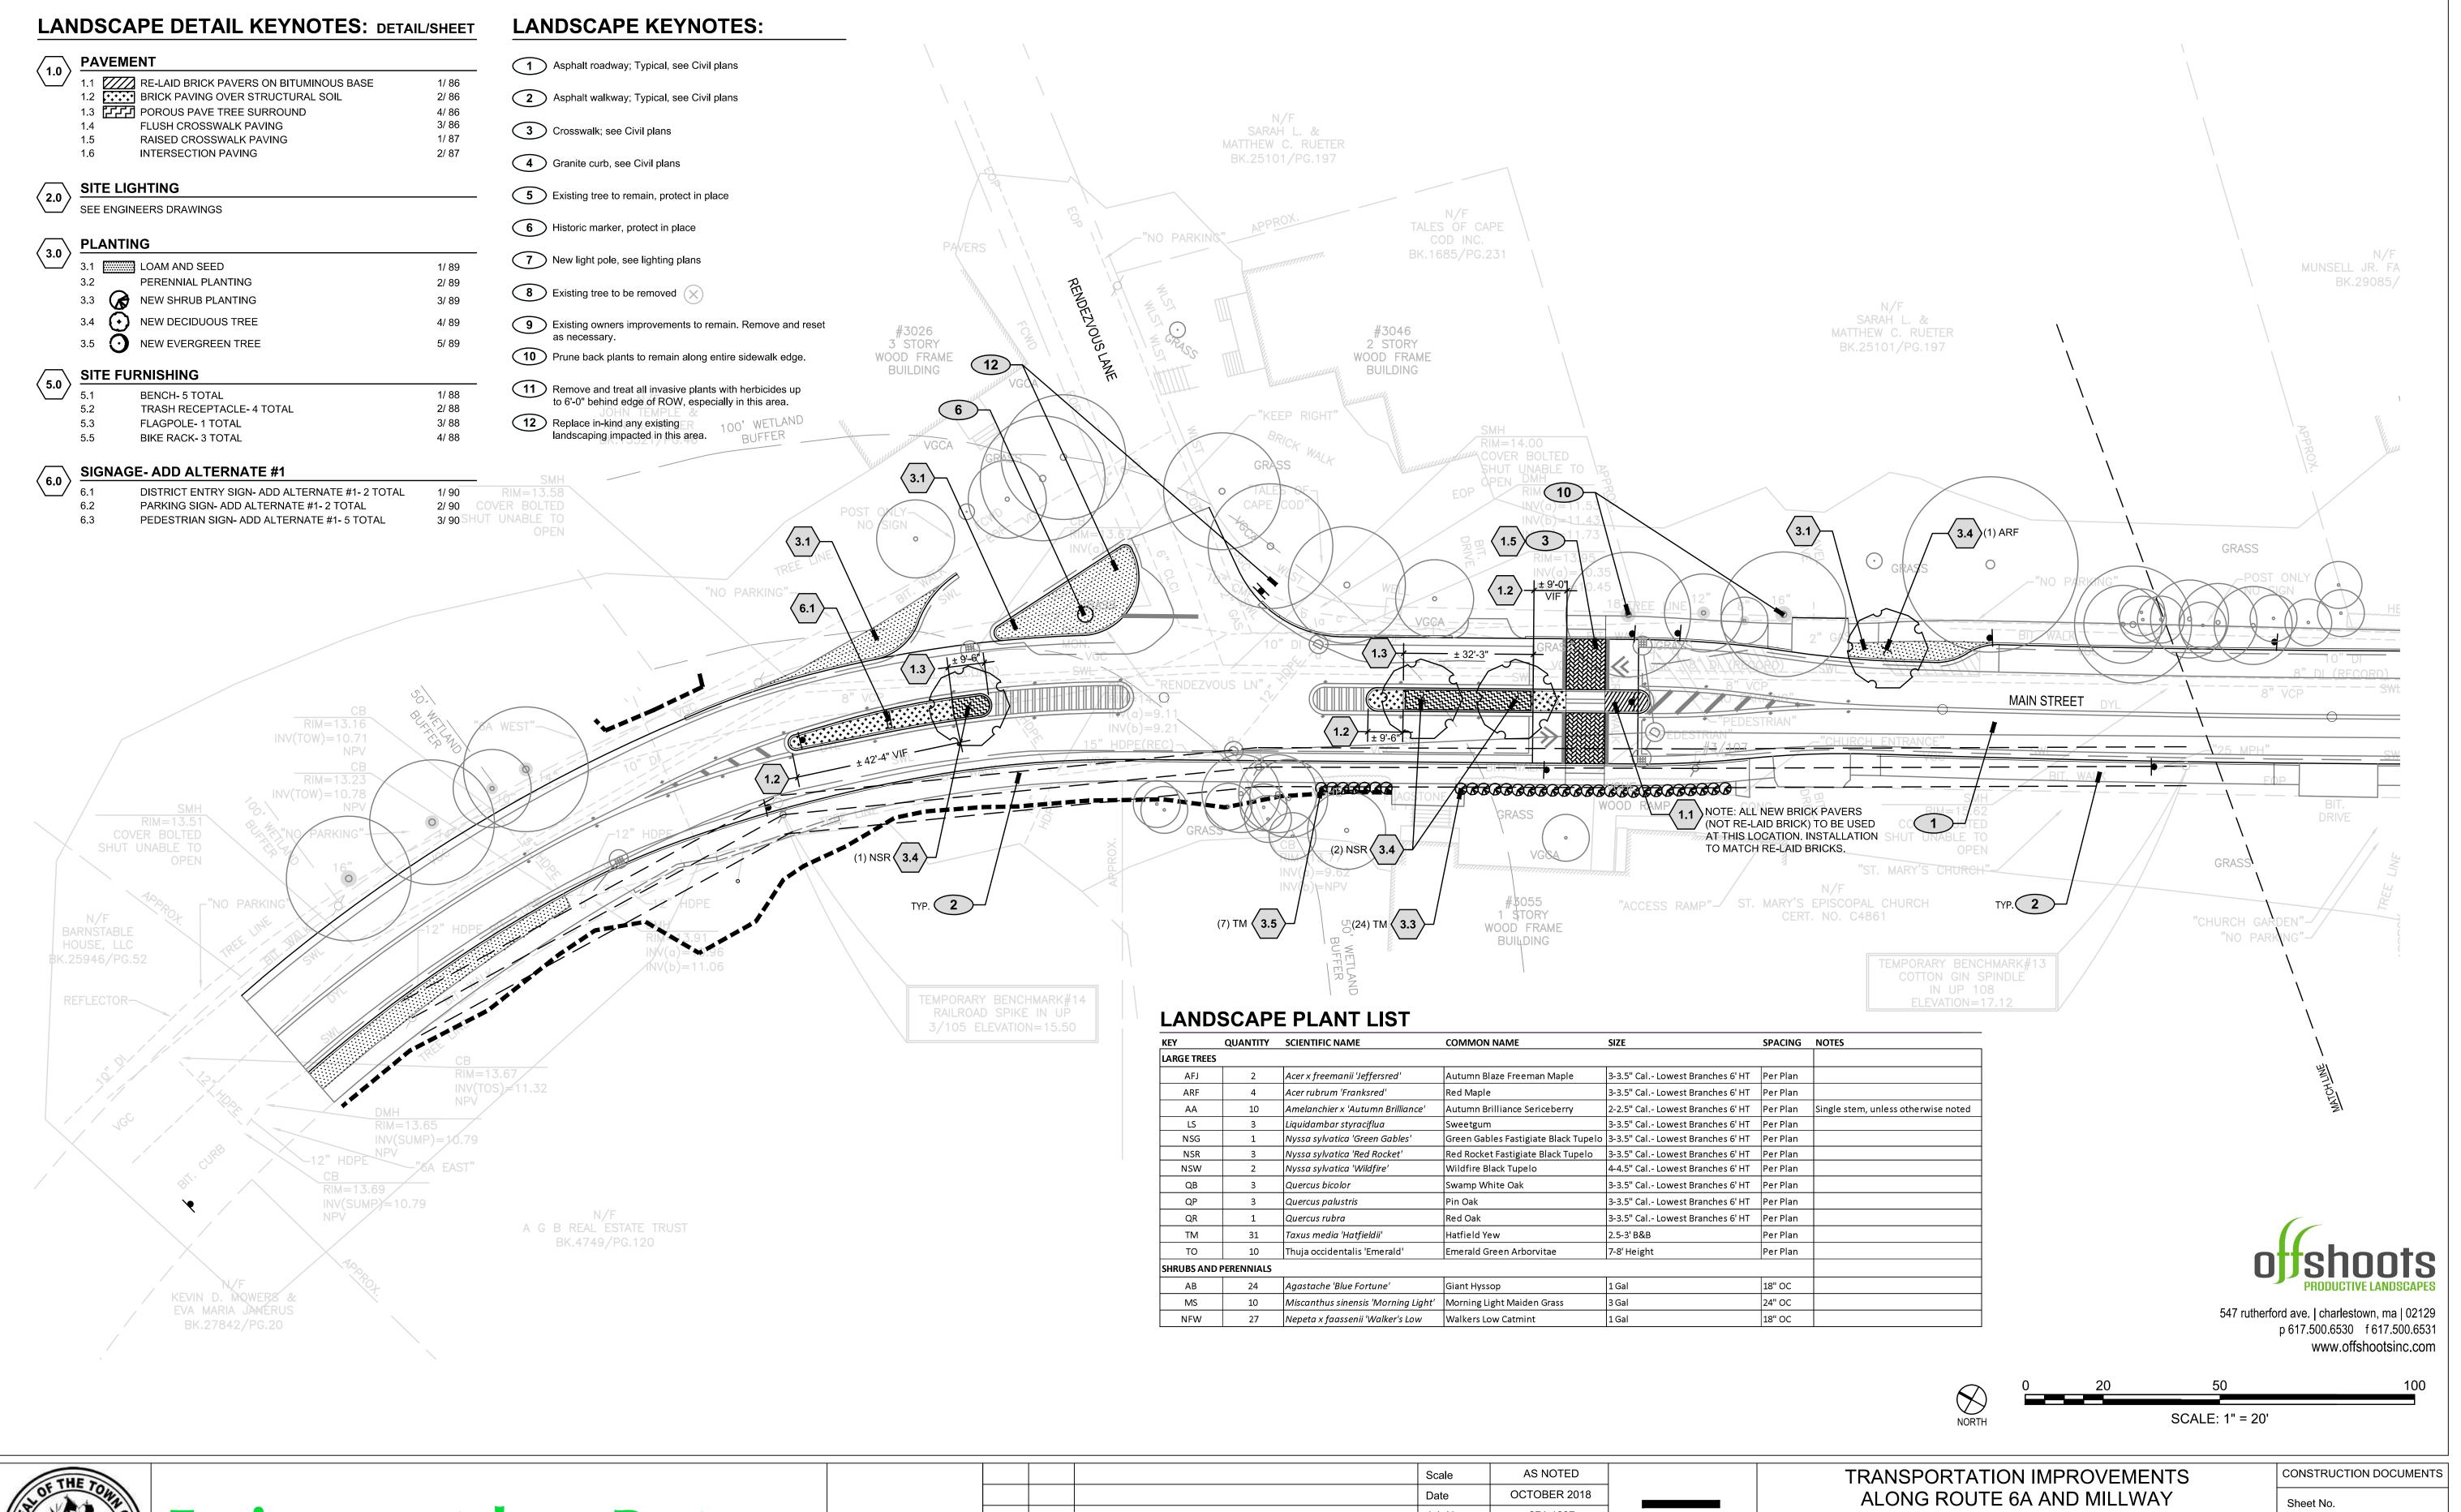
TRANSPORTATION IMPROVEMENTS ALONG MAIN STREET (ROUTE 6A) AND MILLWAY BARNSTABLE, MASSACHUSETTS

TRAFFIC MANAGEMENT PLAN

Sheet No.

NOT FOR CONSTRUCTION

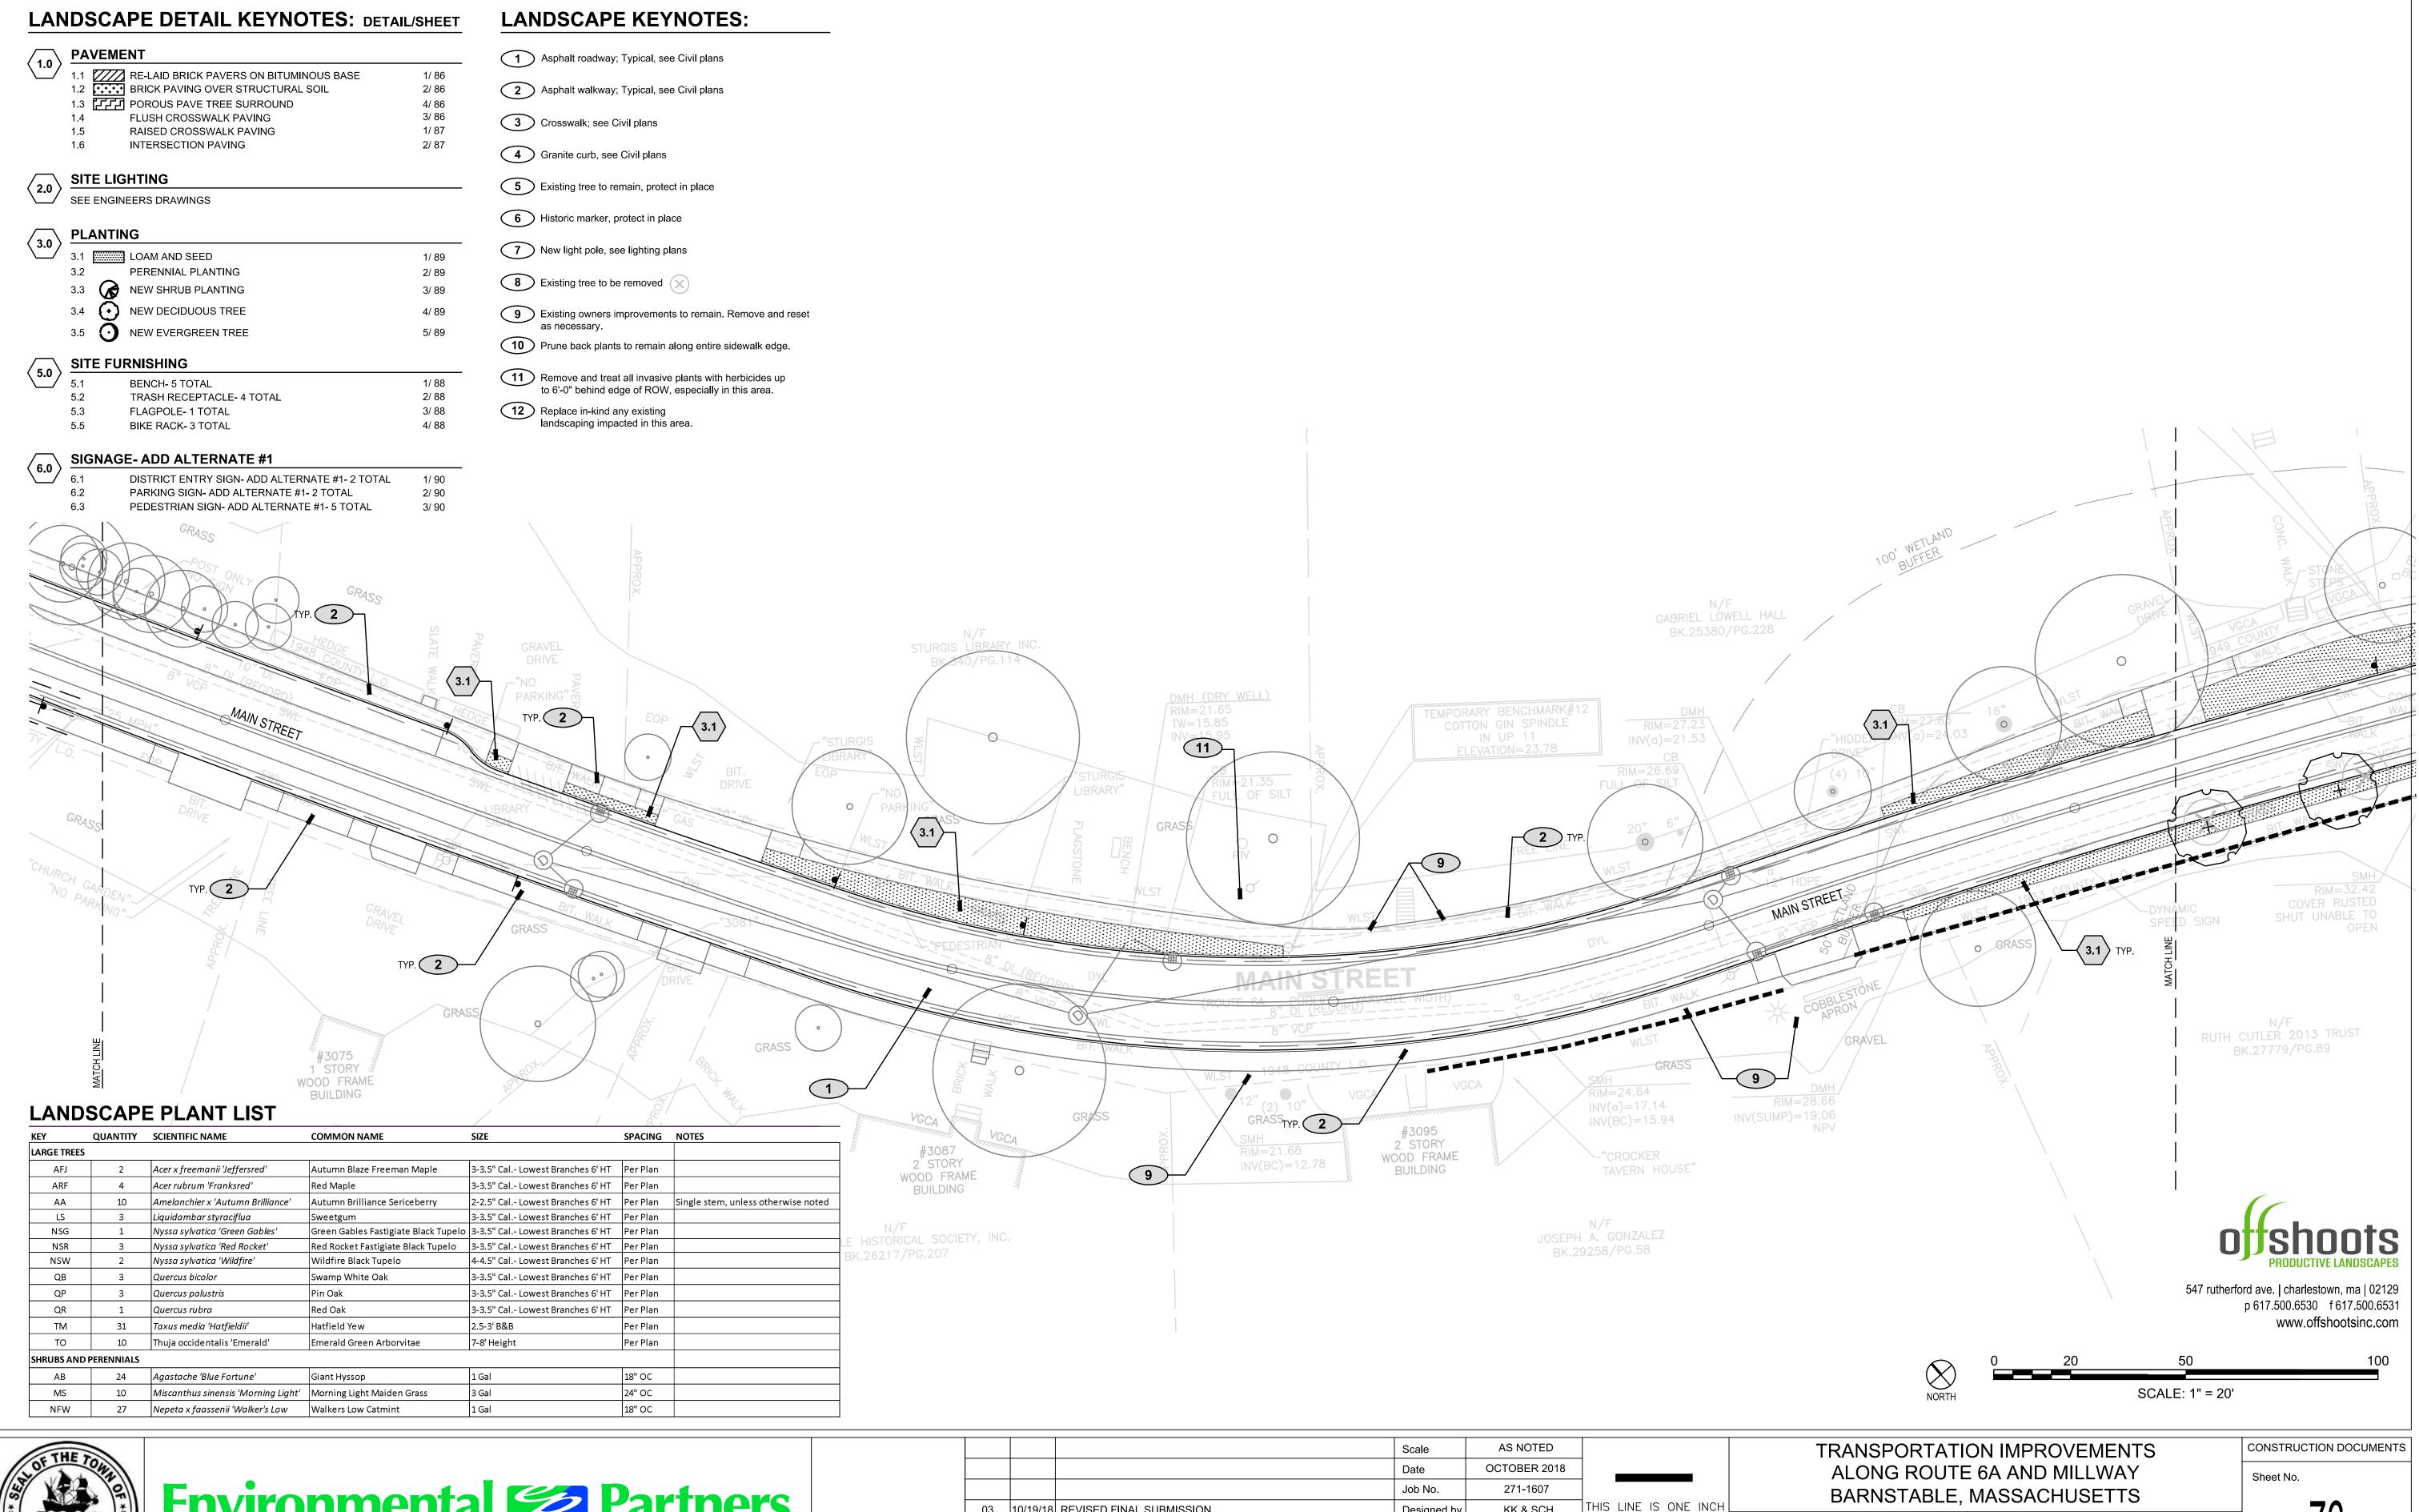






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MARK	DATE	DESCRIPTION	Approved by	KK	

BARNSTABLE, MASSACHUSETTS NE IS ONE INCH

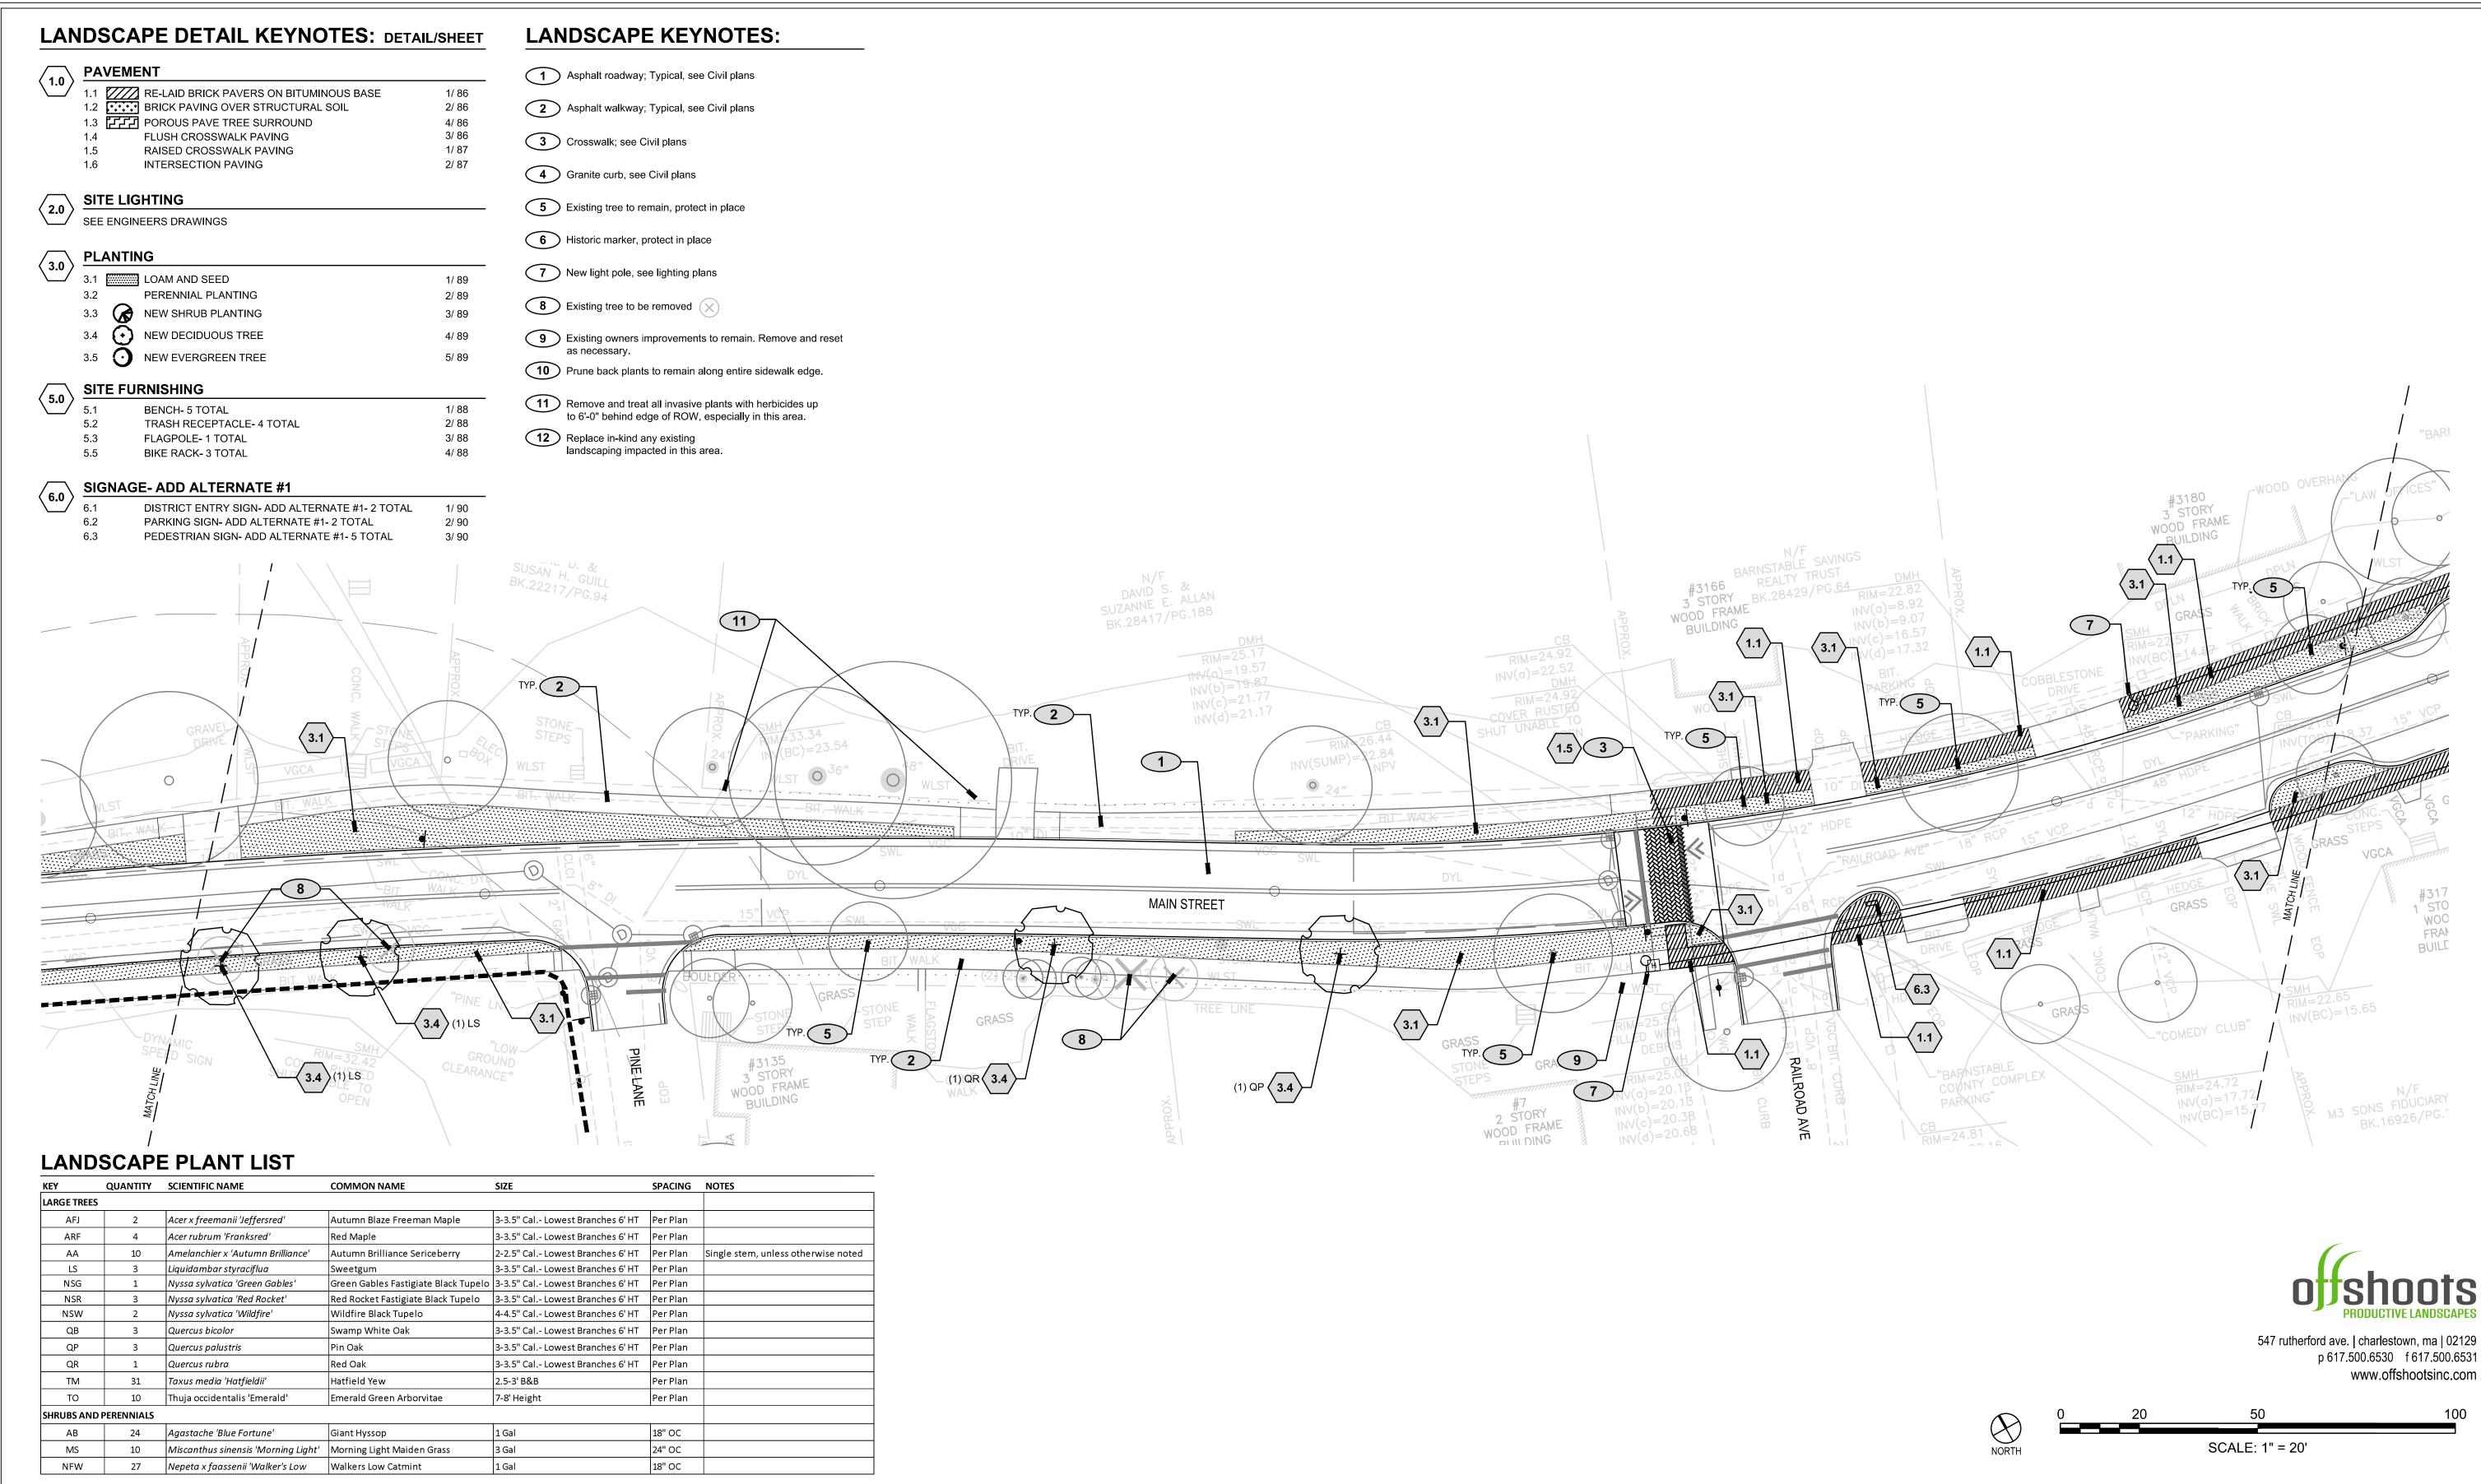


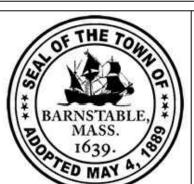


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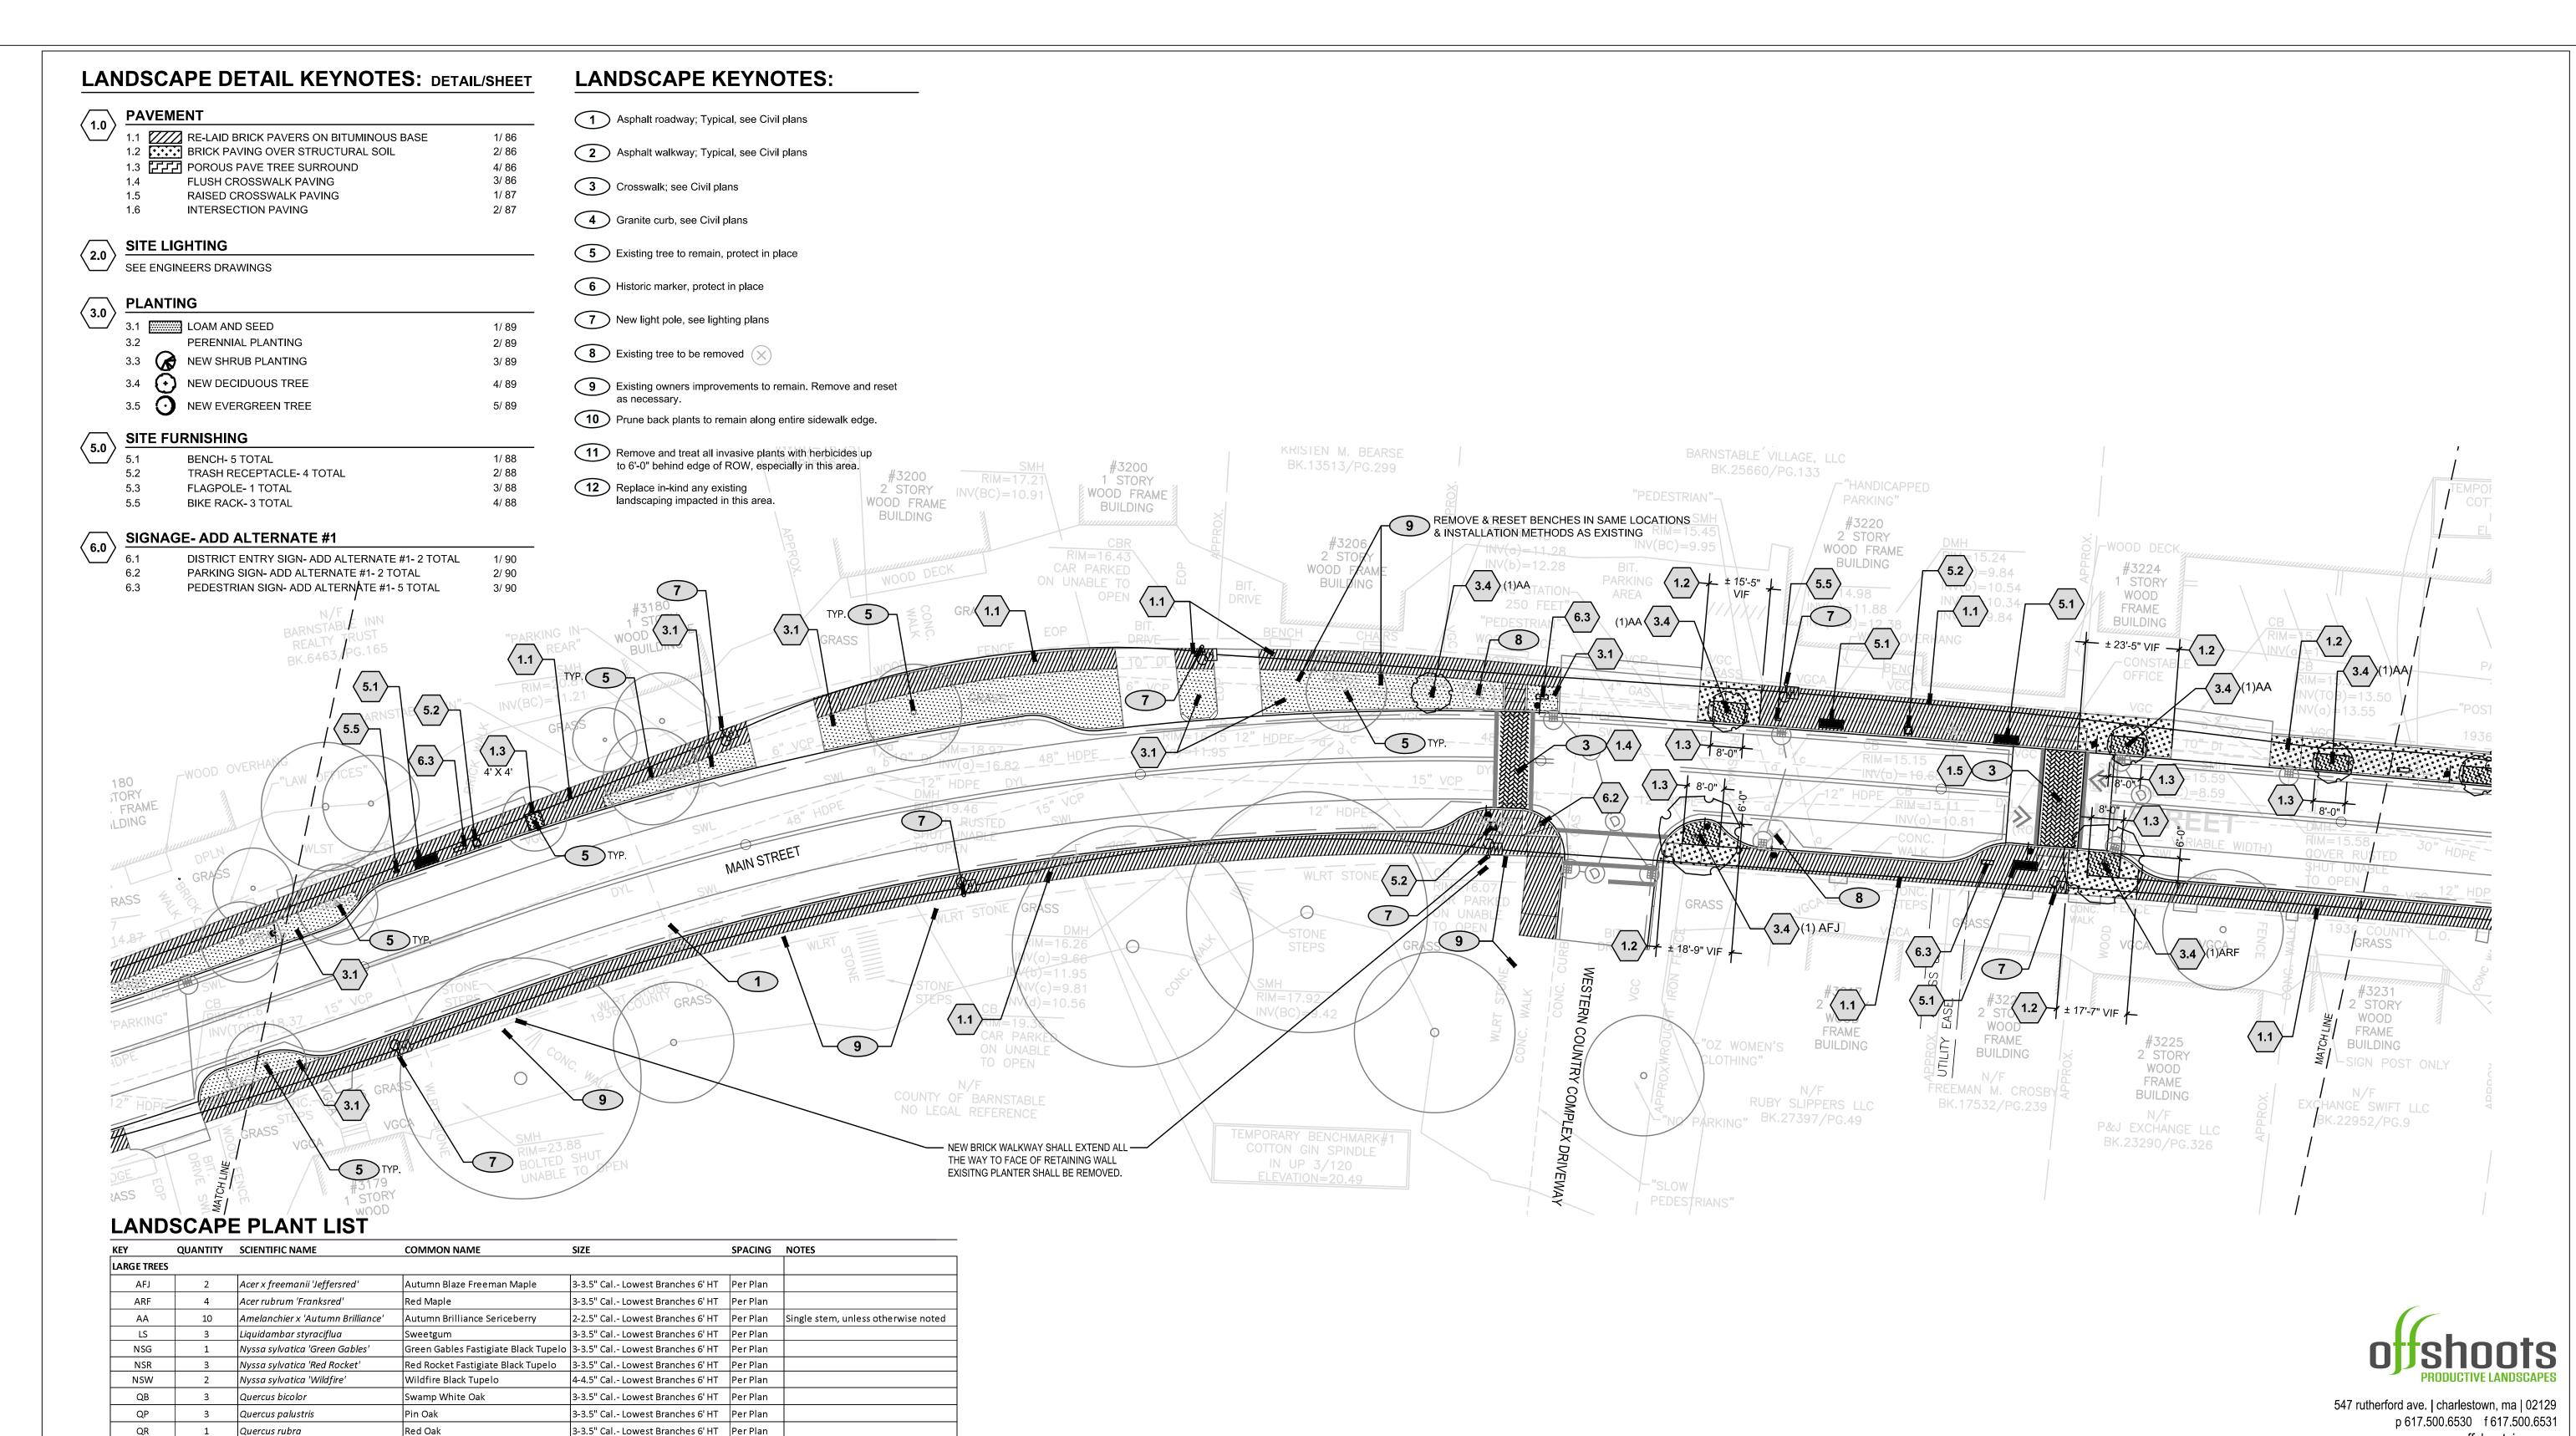
TRANSPORTATION IMPROVEMENTS
ALONG ROUTE 6A AND MILLWAY
BARNSTABLE, MASSACHUSETTS

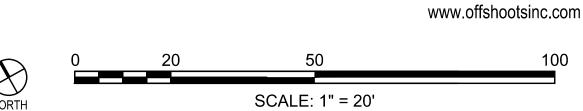
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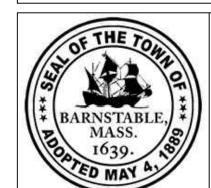
LANDSCAPE MATERIAL PLAN- 03

77

CONSTRUCTION DOCUMENTS







TO

SHRUBS AND PERENNIALS

10

Taxus media 'Hatfieldii'

Thuja occidentalis 'Emerald'

Agastache 'Blue Fortune'

Nepeta x faassenii 'Walker's Low

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7-8' Height

3 Gal

Per Plan

18" OC

24" OC

18" OC

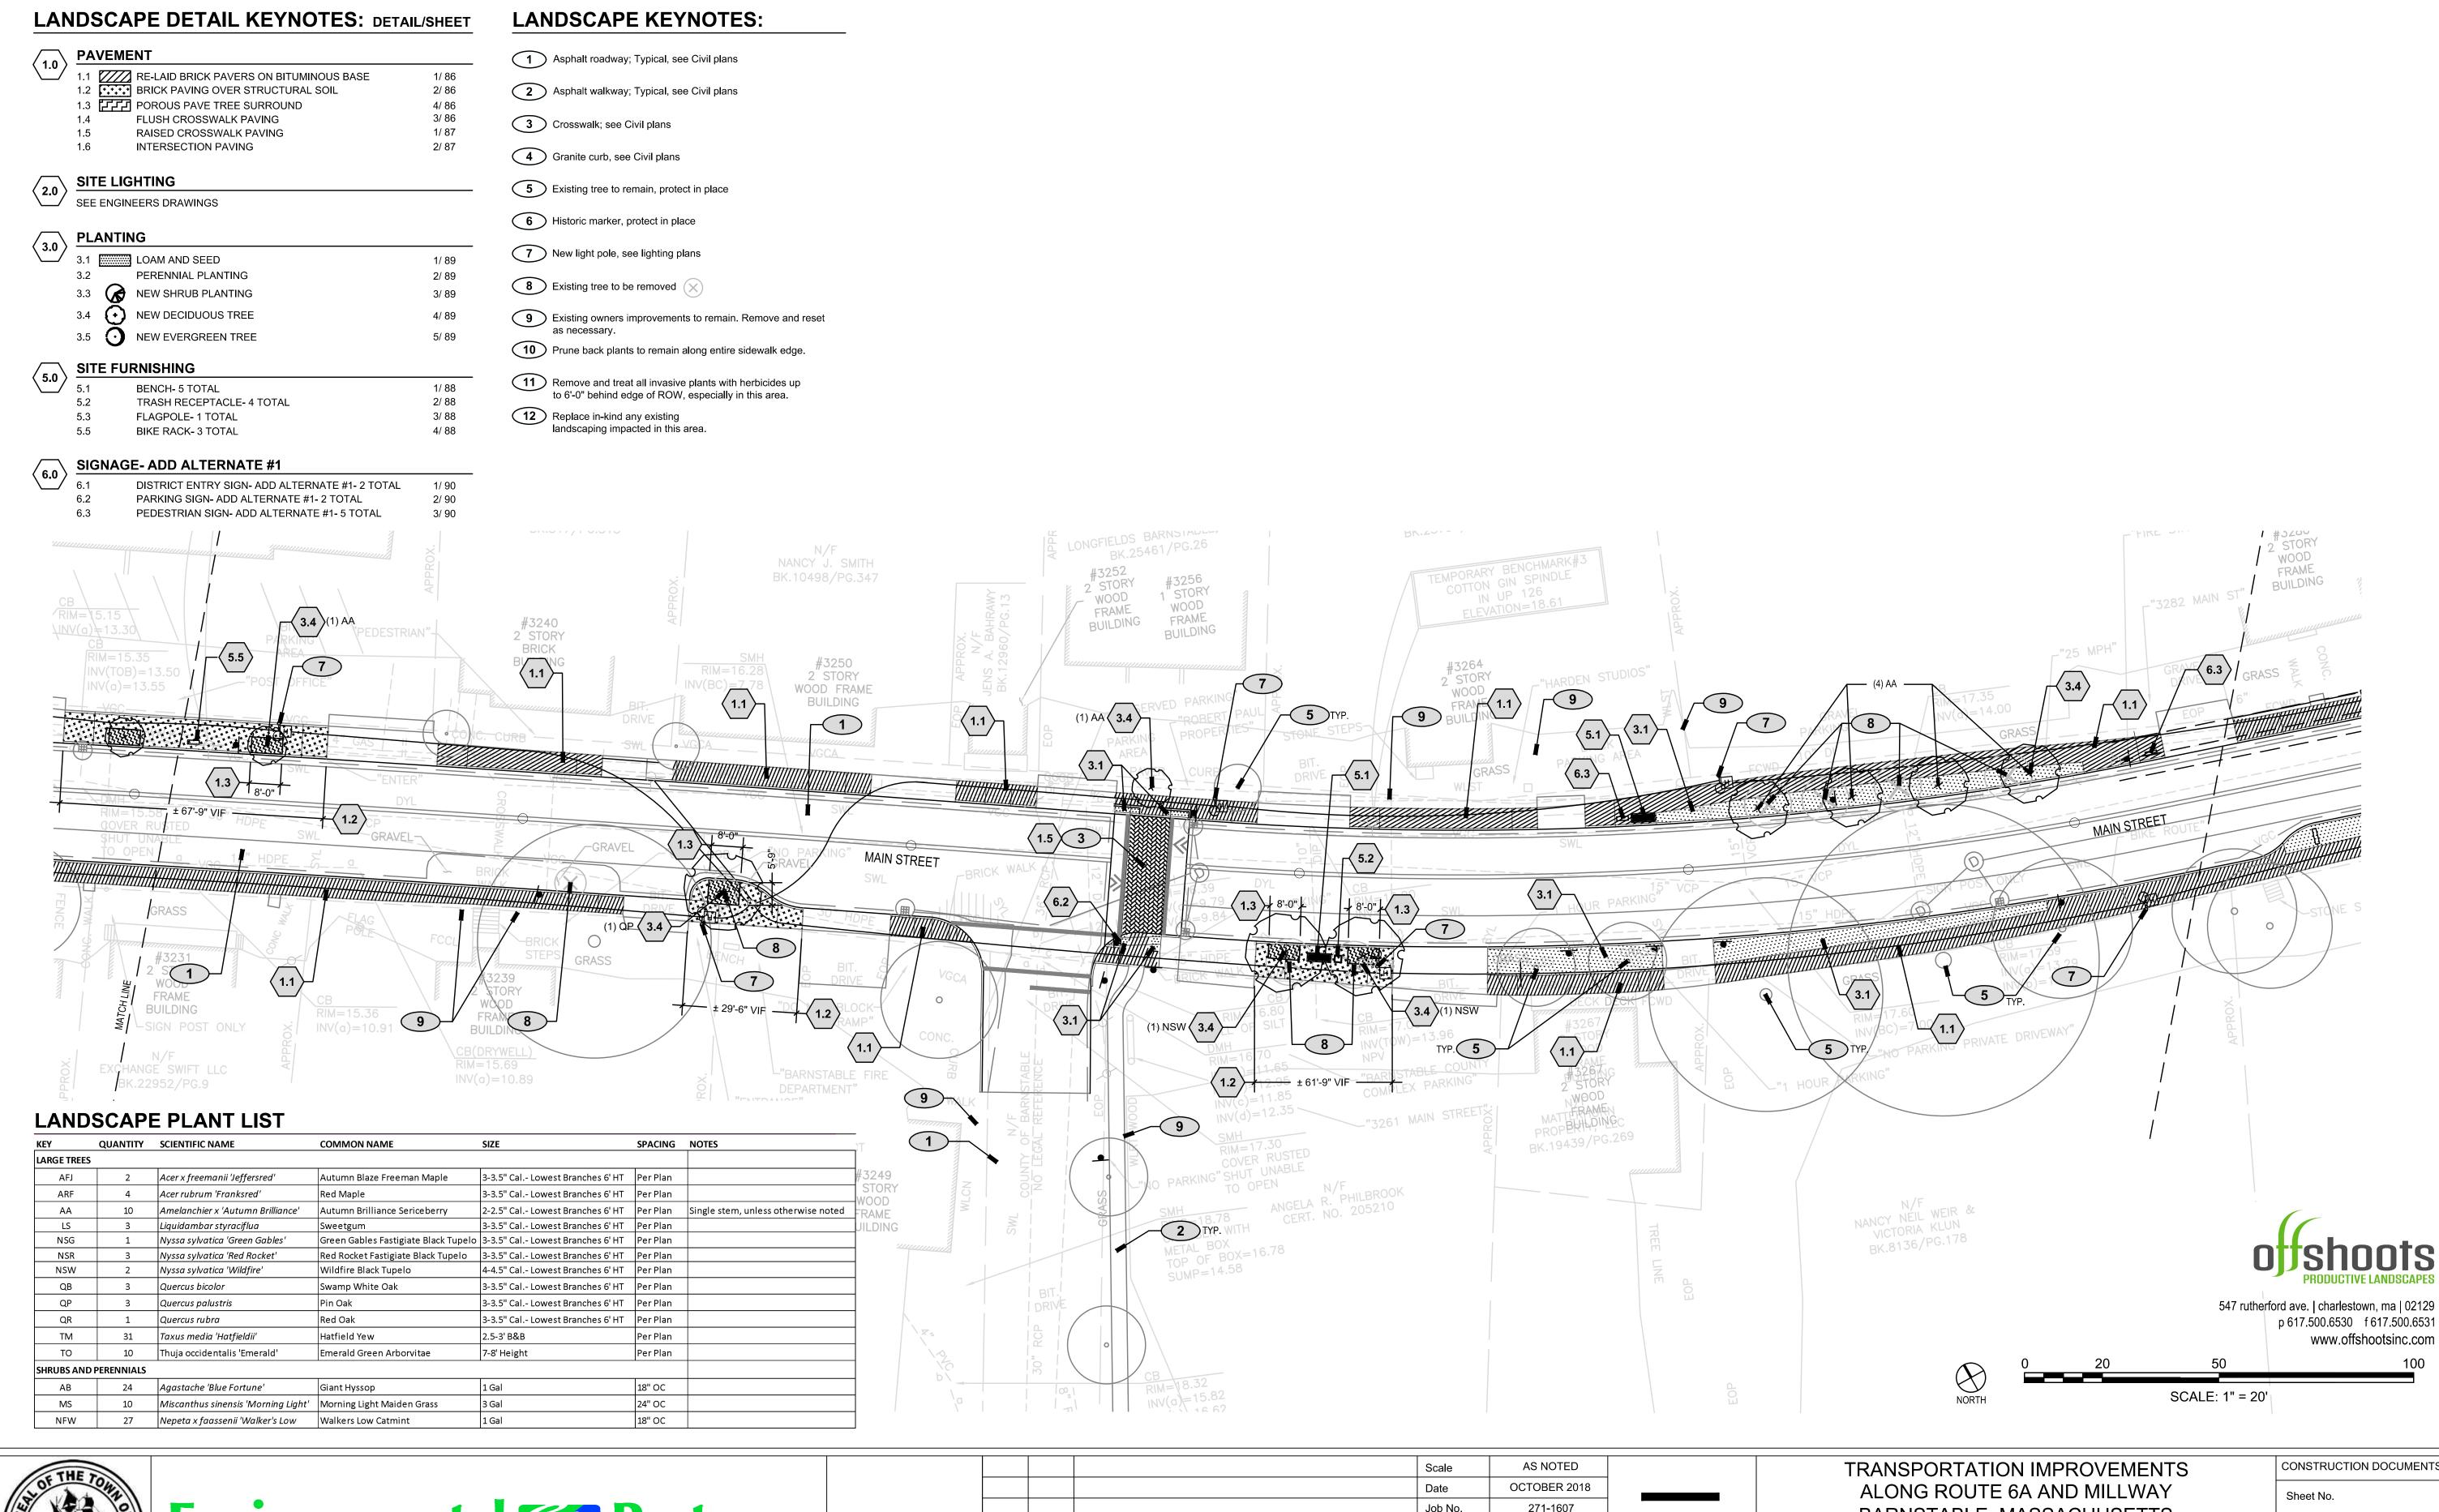
Emerald Green Arborvitae

Miscanthus sinensis 'Morning Light' | Morning Light Maiden Grass

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TRANSPORTATION IMPROVEMENTS ALONG ROUTE 6A AND MILLWAY BARNSTABLE, MASSACHUSETTS INE IS ONE INCH

CONSTRUCTION DOCUMENTS Sheet No.



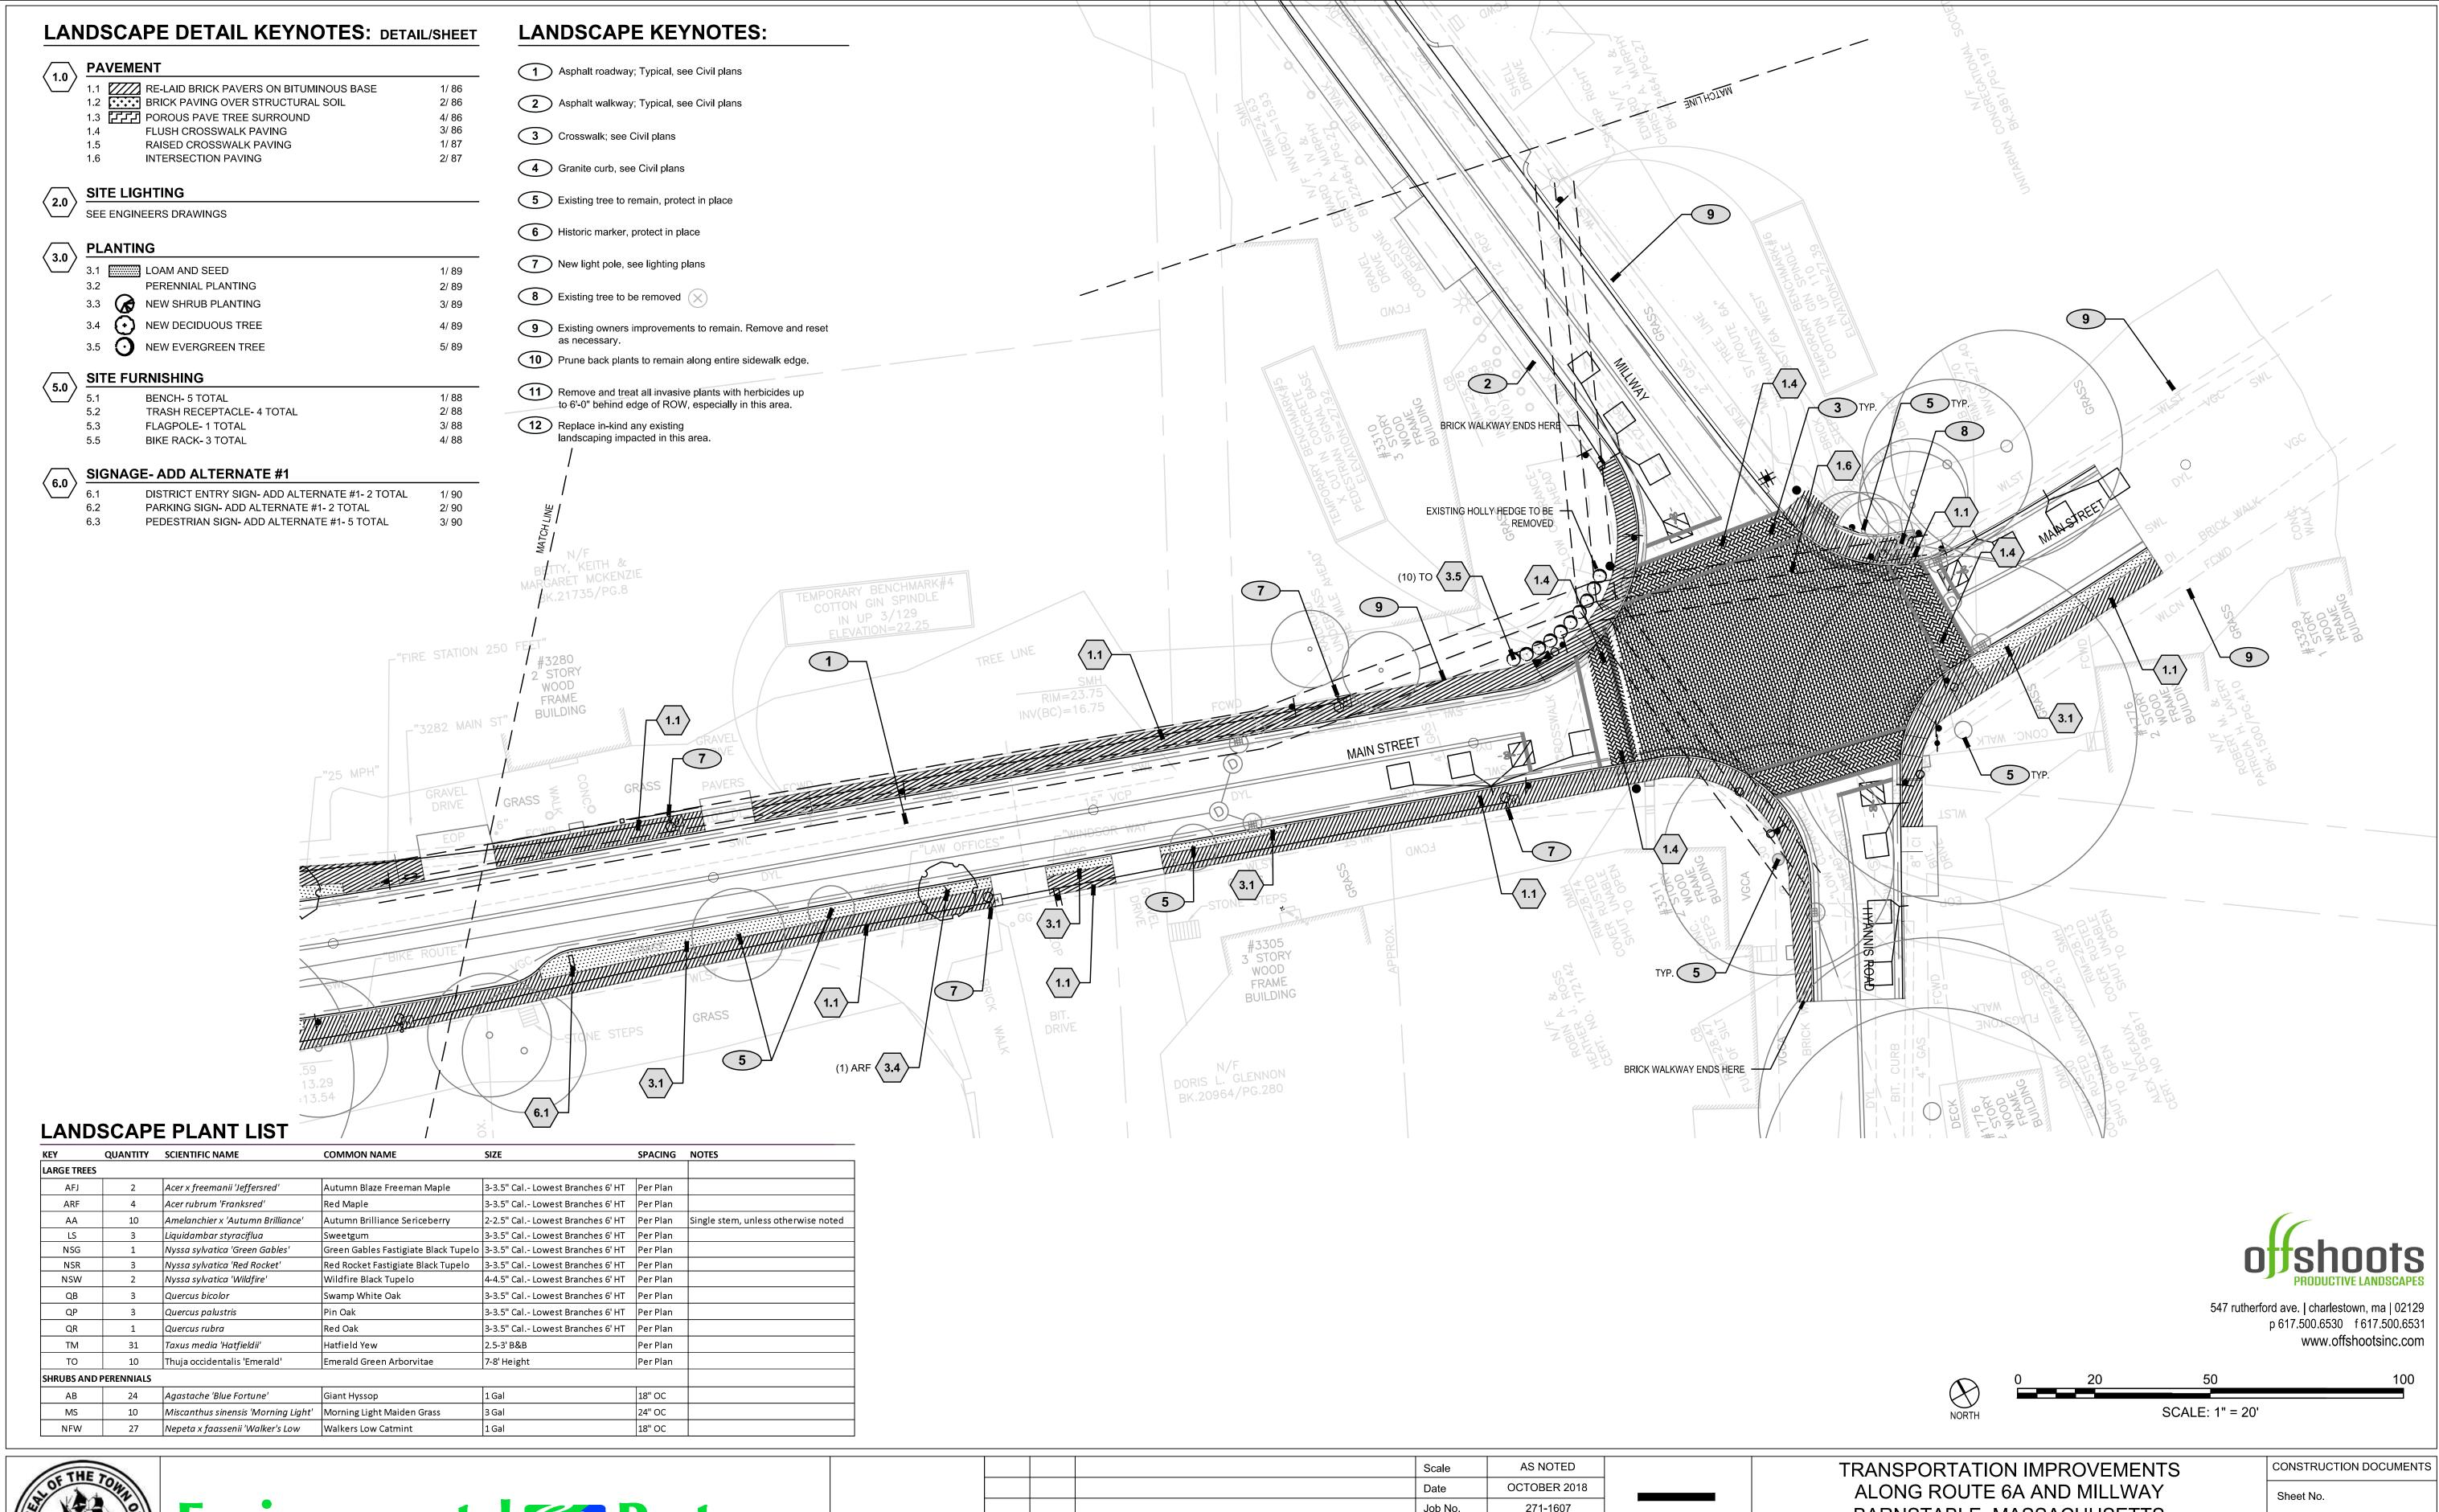




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BARNSTABLE, MASSACHUSETTS

CONSTRUCTION DOCUMENTS





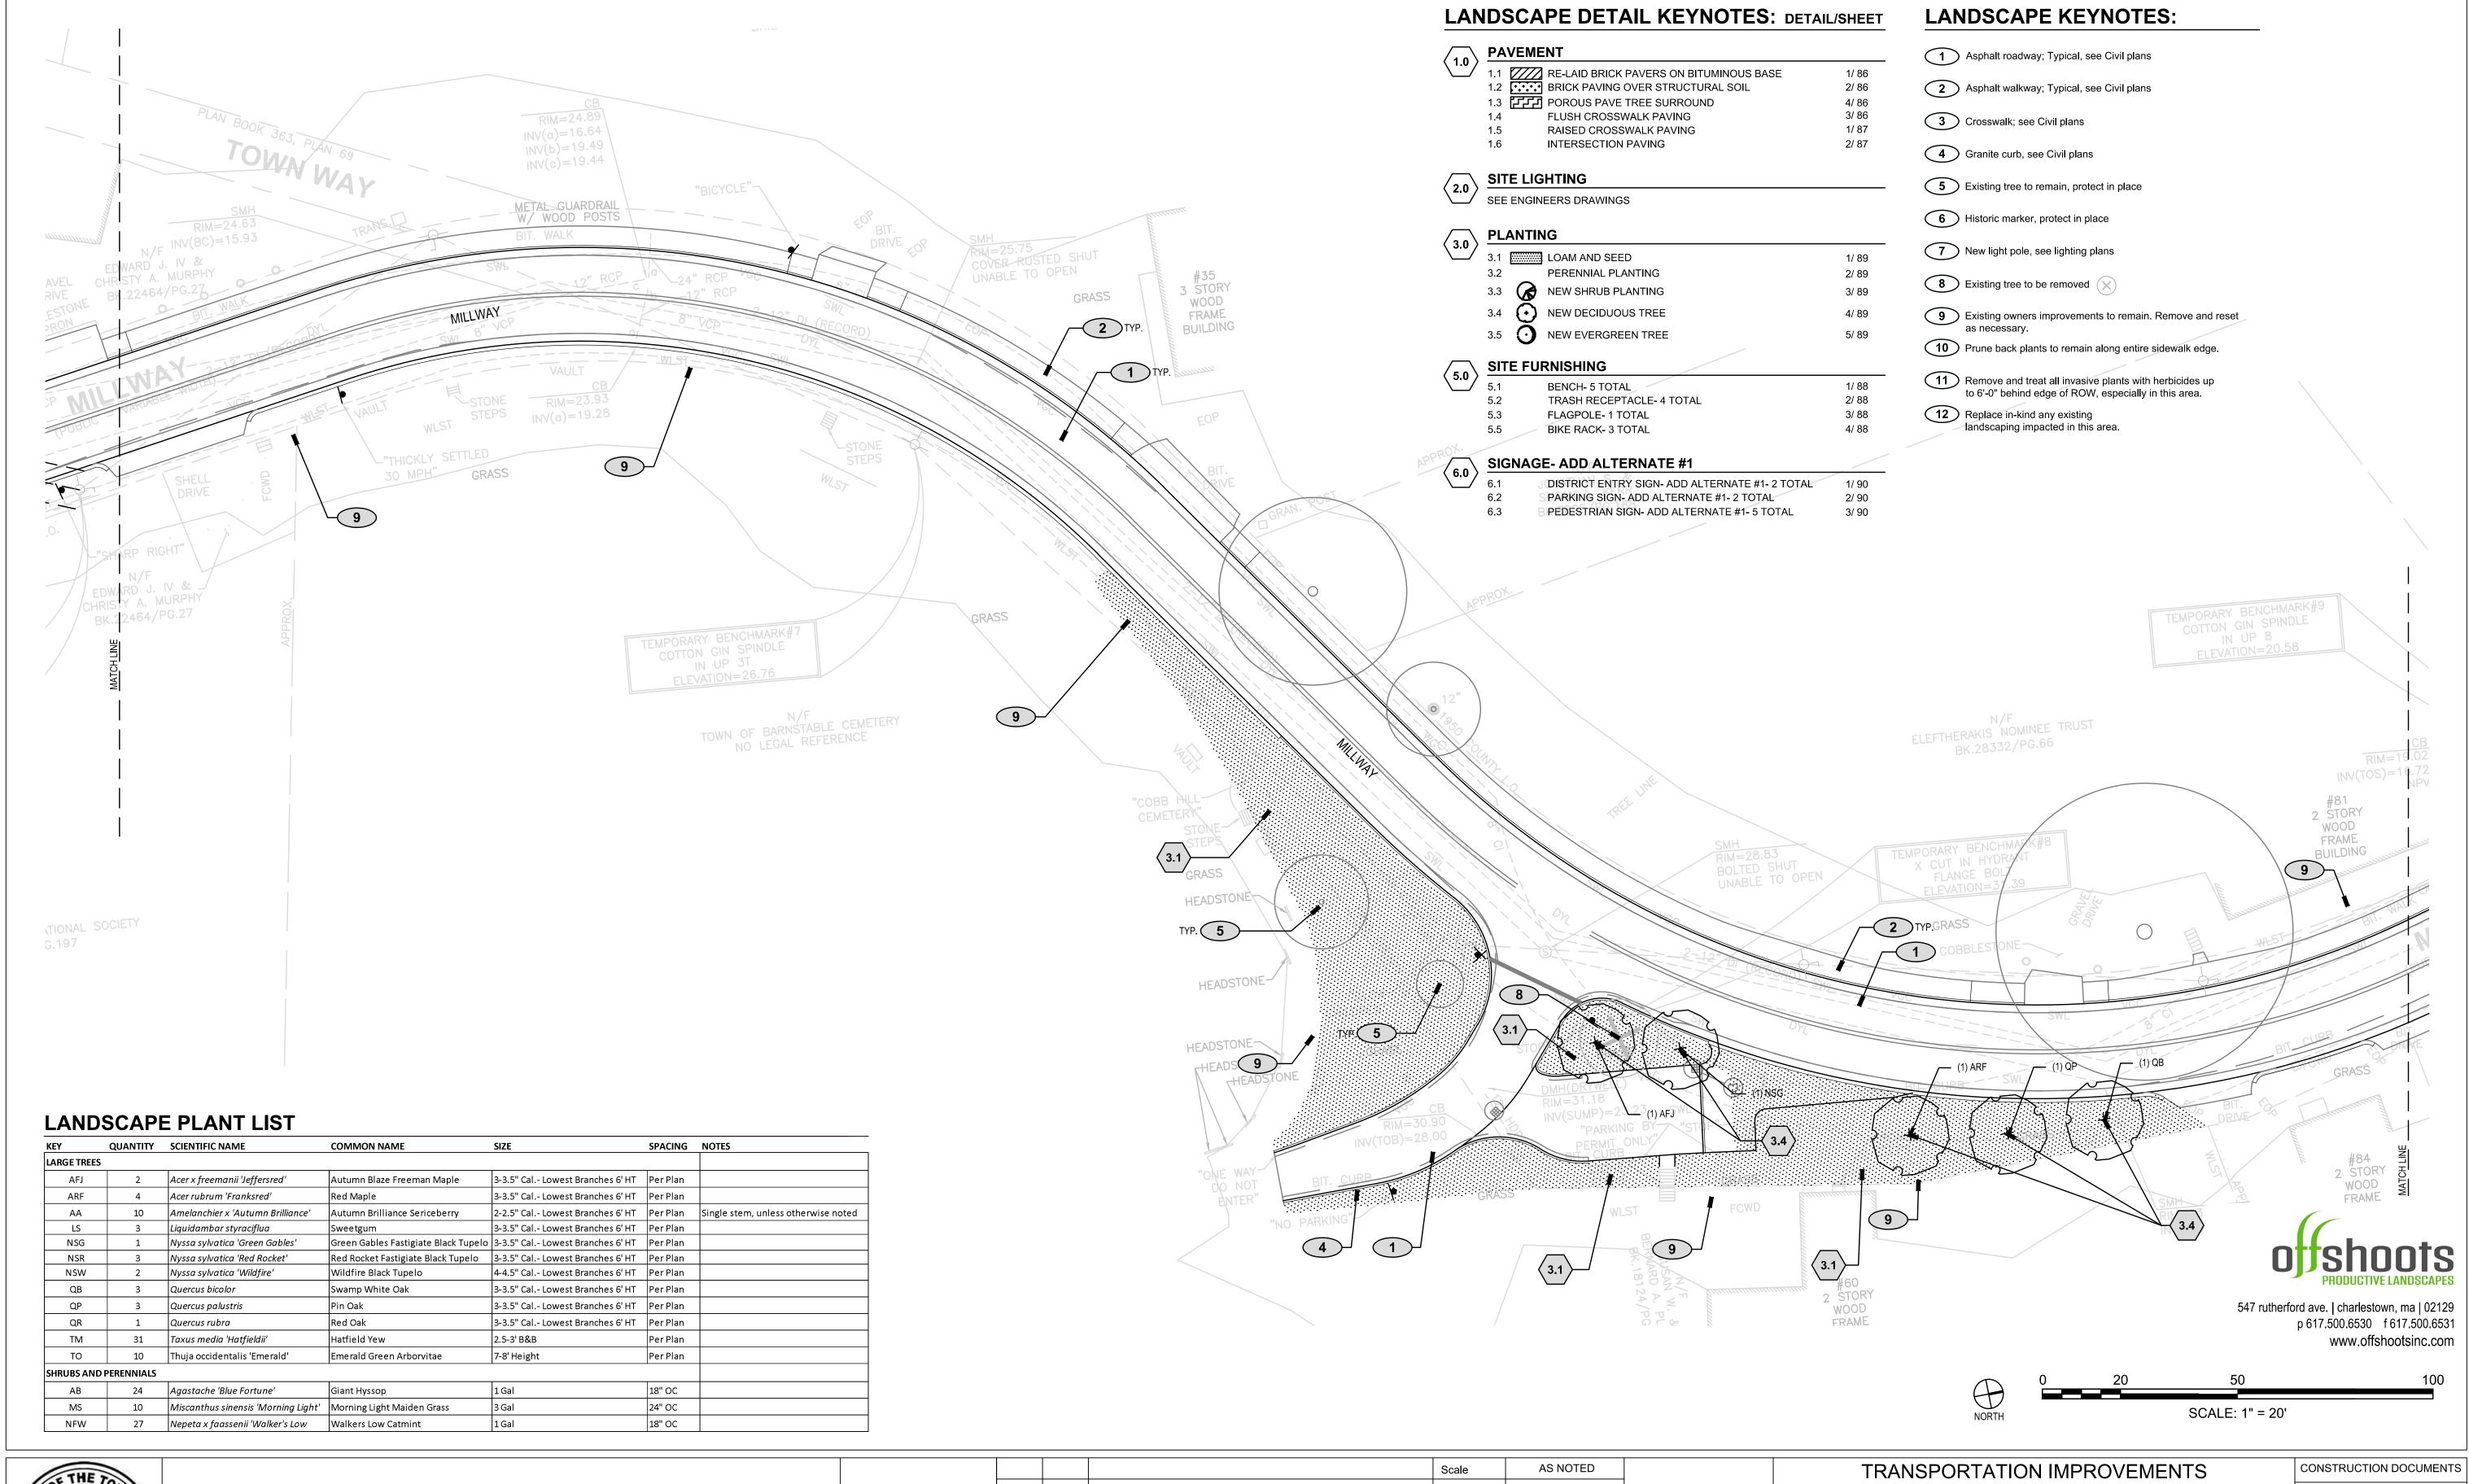


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MARK	DATE	DESCRIPTION	Approved by	KK	

ALONG ROUTE 6A AND MILLWAY
BARNSTABLE, MASSACHUSETTS
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LANDSCAPE MATERIAL PLAN- 06

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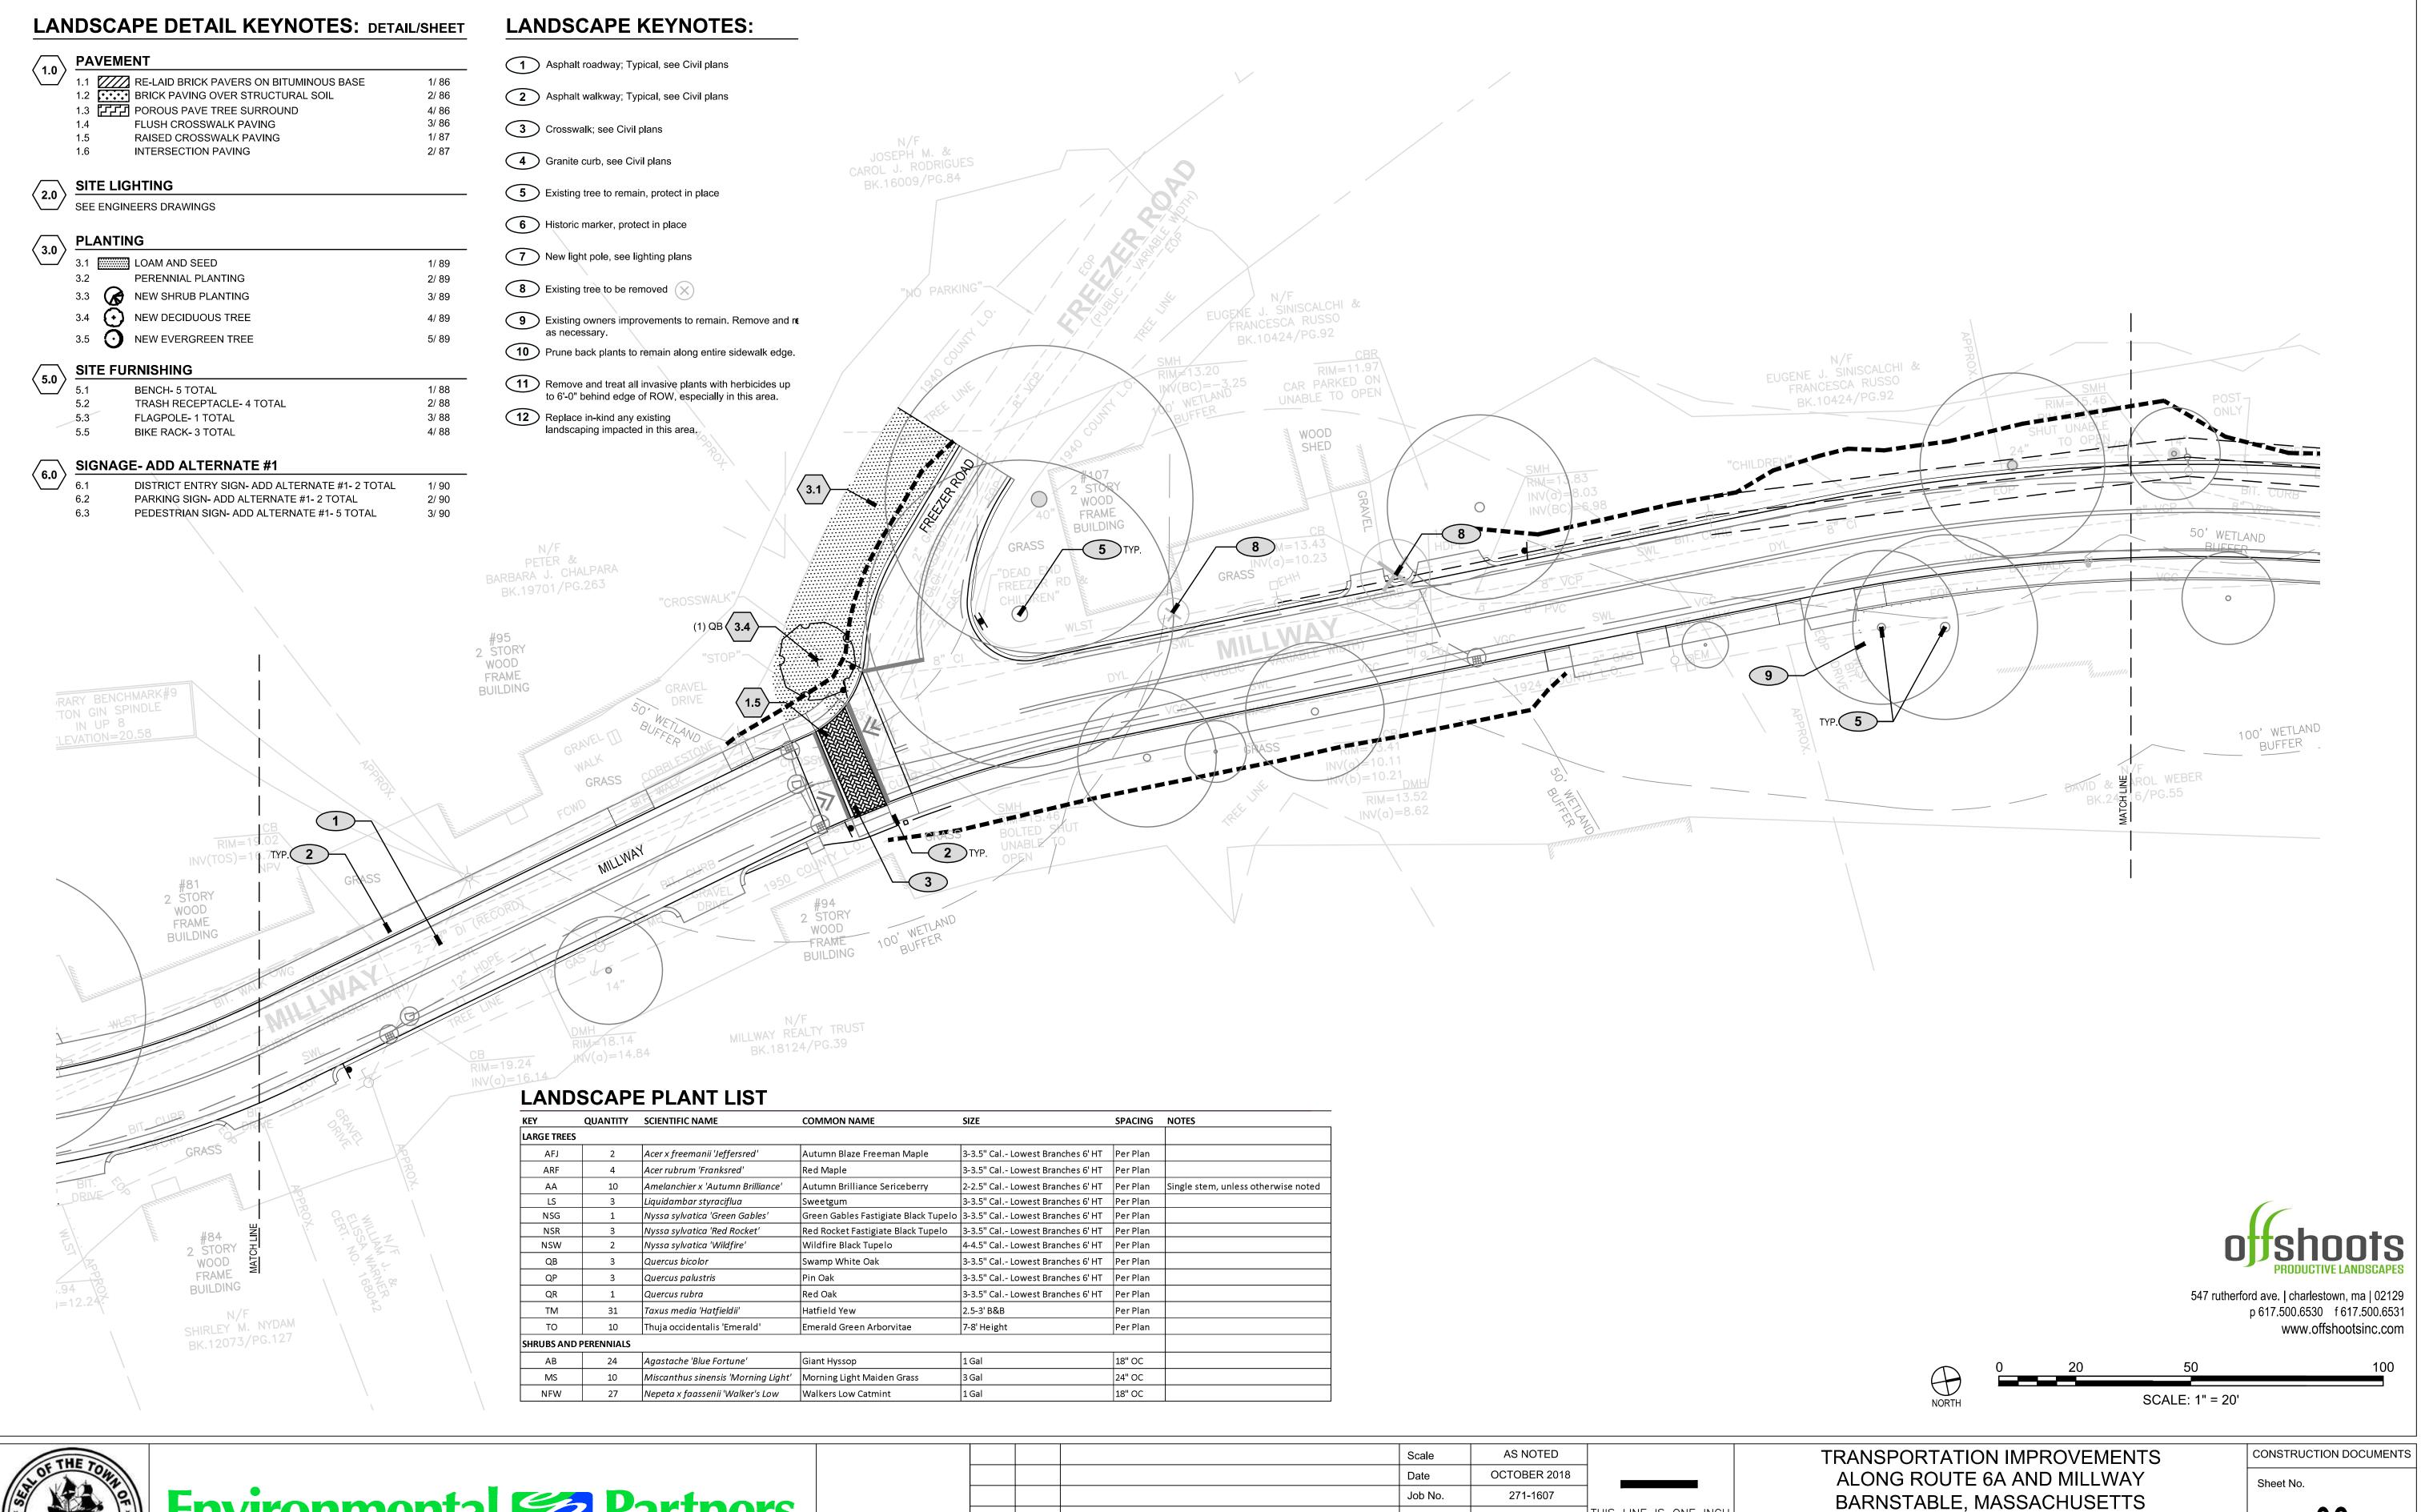




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ALONG ROUTE 6A AND MILLWAY BARNSTABLE, MASSACHUSETTS NG WHEN PLOTTED FULL SCALE ON A "X 34" DRAWING

Sheet No.

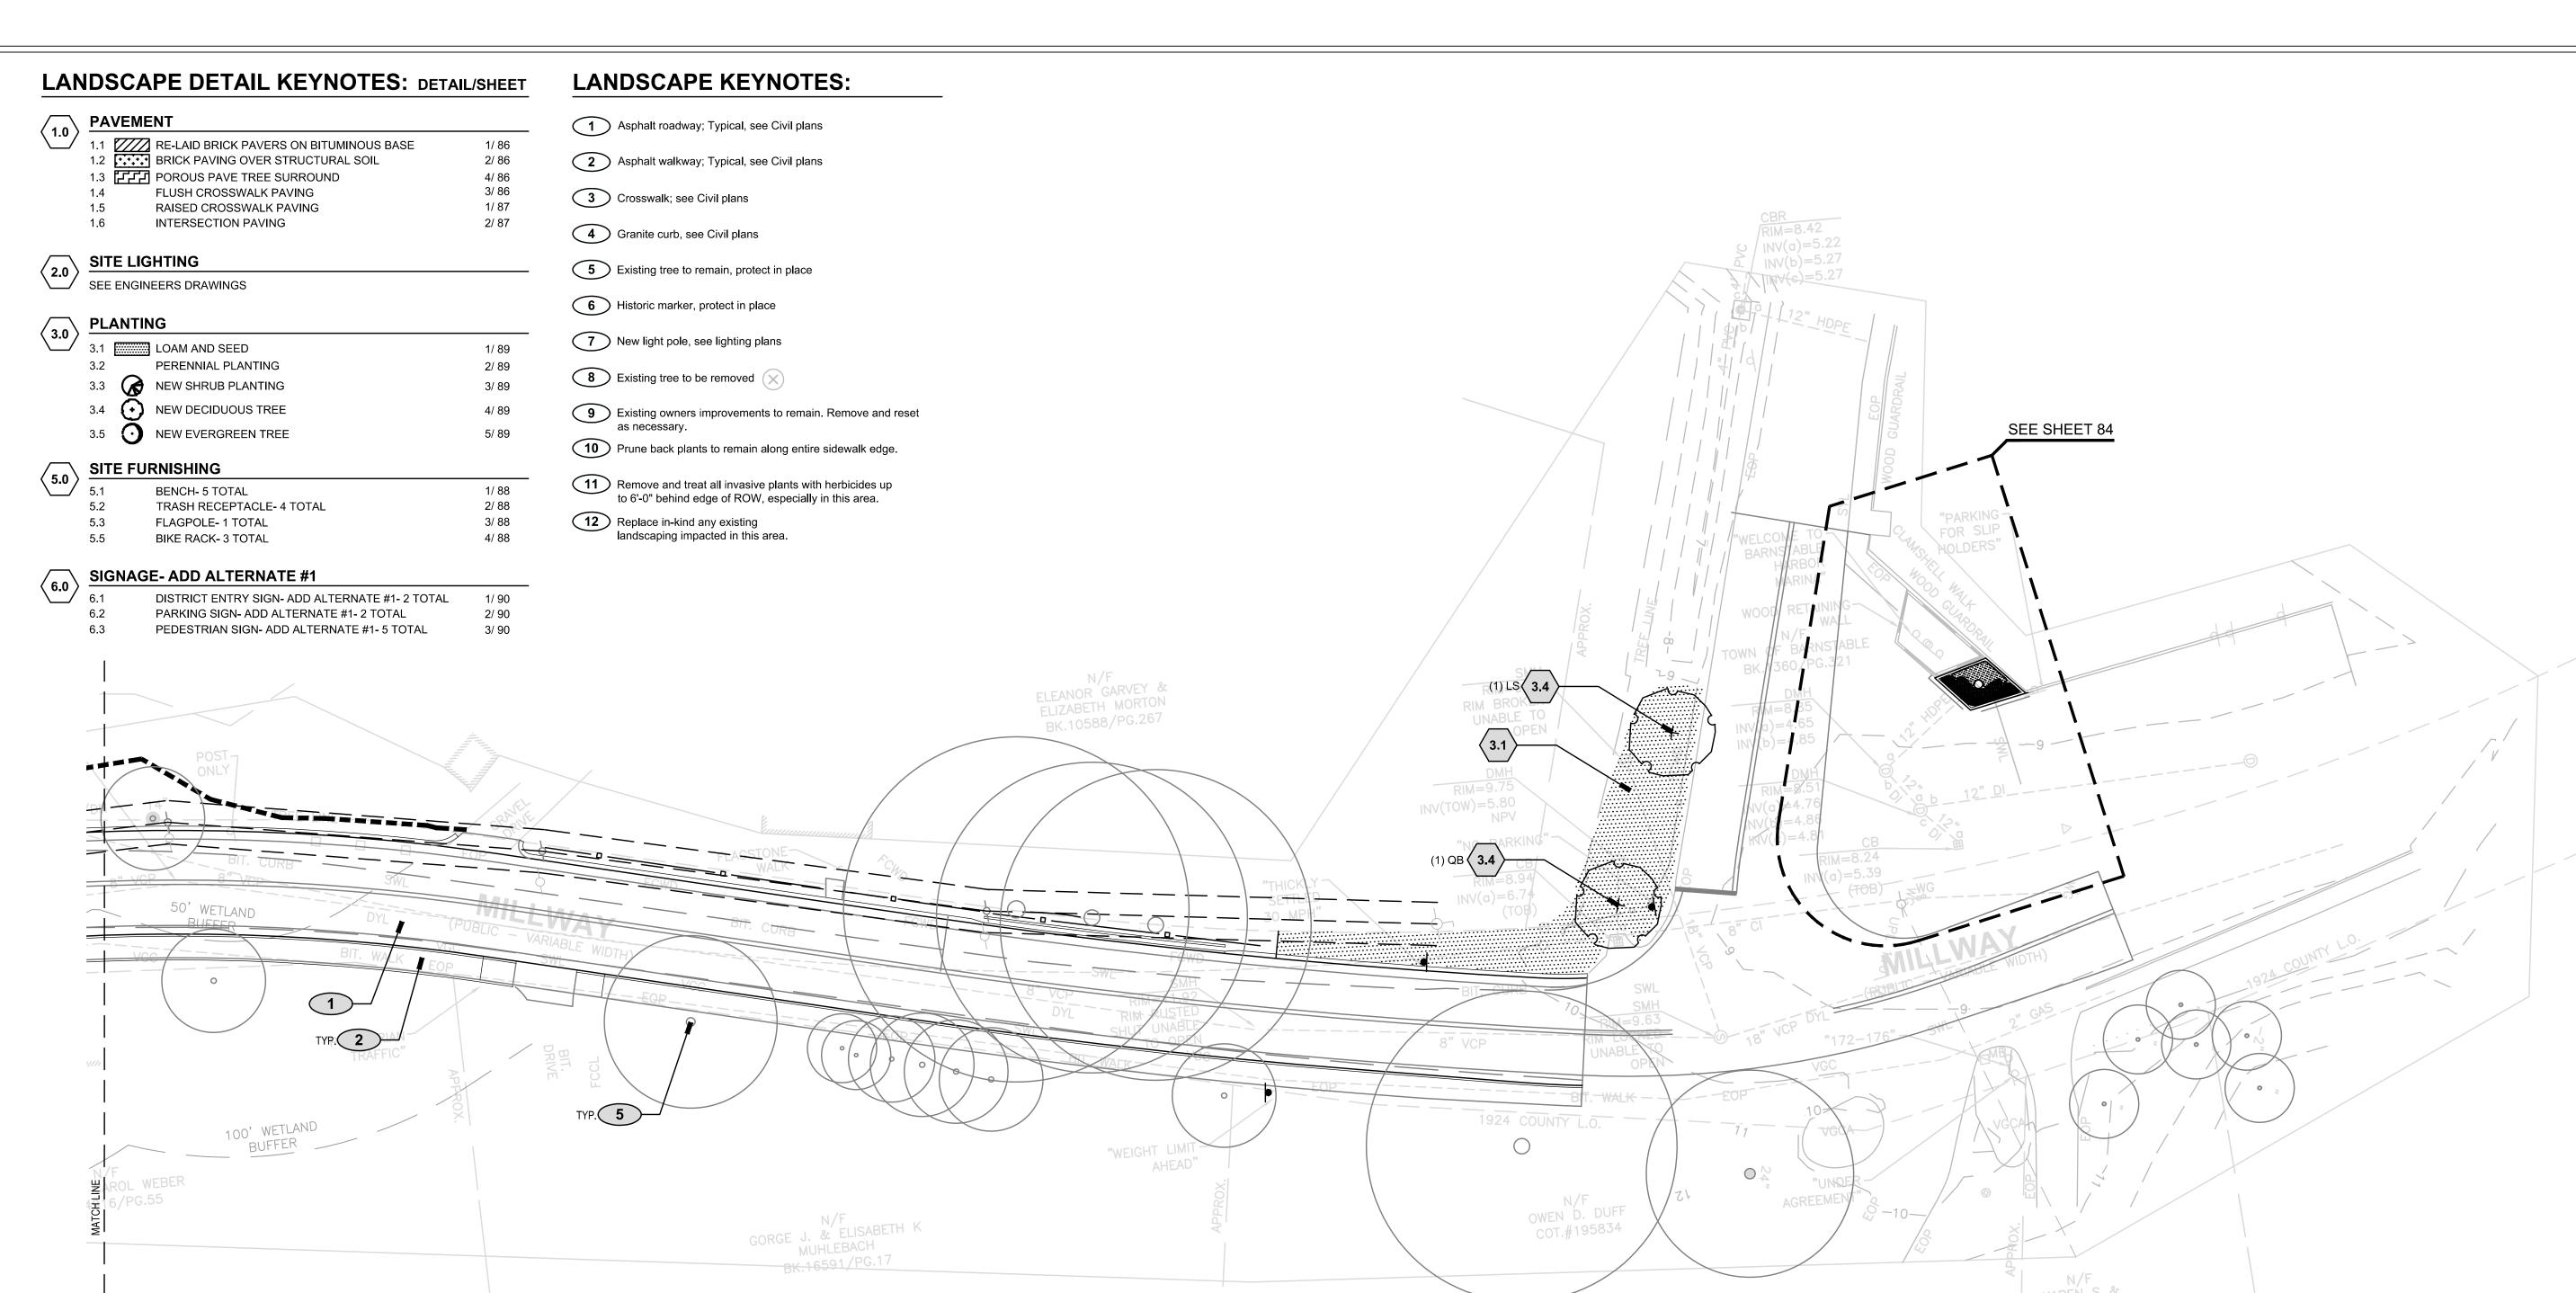






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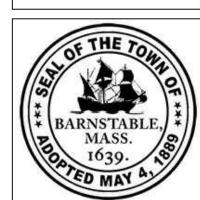


#### LANDSCAPE PLANT LIST

KEY	QUANTITY	SCIENTIFIC NAME	COMMON NAME	SIZE	SPACING	NOTES
LARGE TRE	ES					
AFJ	2	Acer x freemanii 'Jeffersred'	Autumn Blaze Freeman Maple	3-3.5" Cal Lowest Branches 6' HT	Per Plan	
ARF	4	Acer rubrum 'Franksred'	Red Maple	3-3.5" Cal Lowest Branches 6' HT	Per Plan	
AA	10	Amelanchier x 'Autumn Brilliance'	Autumn Brilliance Sericeberry	2-2.5" Cal Lowest Branches 6' HT	Per Plan	Single stem, unless otherwise noted
LS	3	Liquidambar styraciflua	Sweetgum	3-3.5" Cal Lowest Branches 6' HT	Per Plan	
NSG	1	Nyssa sylvatica 'Green Gables'	Green Gables Fastigiate Black Tupelo	3-3.5" Cal Lowest Branches 6' HT	Per Plan	
NSR	3	Nyssa sylvatica 'Red Rocket'	Red Rocket Fastigiate Black Tupelo	3-3.5" Cal Lowest Branches 6' HT	Per Plan	
NSW	2	Nyssa sylvatica 'Wildfire'	Wildfire Black Tupelo	4-4.5" Cal Lowest Branches 6' HT	Per Plan	
QB	3	Quercus bicolor	Swamp White Oak	3-3.5" Cal Lowest Branches 6' HT	Per Plan	
QP	3	Quercus palustris	Pin Oak	3-3.5" Cal Lowest Branches 6' HT	Per Plan	
QR	1	Quercus rubra	Red Oak	3-3.5" Cal Lowest Branches 6' HT	Per Plan	
TM	31	Taxus media 'Hatfieldii'	Hatfield Yew	2.5-3' B&B	Per Plan	
то	10	Thuja occidentalis 'Emerald'	Emerald Green Arborvitae	7-8' Height	Per Plan	
SHRUBS AN	ND PERENNIALS				•	
АВ	24	Agastache 'Blue Fortune'	Giant Hyssop	1 Gal	18" OC	
MS	10	Miscanthus sinensis 'Morning Light'	Morning Light Maiden Grass	3 Gal	24" OC	
NFW	27	Nepeta x faassenii 'Walker's Low	Walkers Low Catmint	1 Gal	18" OC	

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TRANSPORTATION IMPROVEMENTS ALONG ROUTE 6A AND MILLWAY BARNSTABLE, MASSACHUSETTS LINE IS ONE INCH NG WHEN PLOTTED FULL SCALE ON A " X 34" DRAWING

LANDSCAPE MATERIAL PLAN- 09

CONSTRUCTION DOCUMENTS

## LANDSCAPE DETAIL KEYNOTES: DETAIL/SHEET

1.0 PAVEMENT

	FAVENIENT						
1.1	RE-LAID BRICK PAVERS ON BITUMINOUS BASE	1/ 86					
1.2	BRICK PAVING OVER STRUCTURAL SOIL	2/ 86					
1.3	POROUS PAVE TREE SURROUND	4/ 86					
1.4	FLUSH CROSSWALK PAVING	3/ 86					
1.5	RAISED CROSSWALK PAVING	1/ 87					
1.6	INTERSECTION PAVING	2/ 87					

SITE LIGHTING

SEE ENGINEERS DRAWINGS

✓ PLANTING

/20\		ANIIN	G	
<b>3.0</b>	3.1		LOAM AND SEED	1/ 89
	3.2		PERENNIAL PLANTING	2/ 89
	3.3	B	NEW SHRUB PLANTING	3/ 89
	3.4	$\odot$	NEW DECIDUOUS TREE	4/ 89
	3.5	0	NEW EVERGREEN TREE	5/ 89
\[ \int \ \ \ \ \ \ \ \ \ \ \ \ \ \ \ \ \ \ \	SIT	E FUF	RNISHING	

FLAGPOLE- 1 TOTAL

BENCH- 5 TOTAL 1/ 88 TRASH RECEPTACLE- 4 TOTAL 2/ 88 3/ 88 BIKE RACK- 3 TOTAL

SIGNAGE- ADD ALTERNATE #1

6.1	DISTRICT ENTRY SIGN- ADD ALTERNATE #1- 2 TOTAL	1/ 90
6.2	PARKING SIGN- ADD ALTERNATE #1- 2 TOTAL	2/ 90
6.3	PEDESTRIAN SIGN- ADD ALTERNATE #1- 5 TOTAL	3/ 90

## LANDSCAPE KEYNOTES:

1 Asphalt roadway; Typical, see Civil plans

2 Asphalt walkway; Typical, see Civil plans

3 Crosswalk; see Civil plans

4 Granite curb, see Civil plans

**5** Existing tree to remain, protect in place

6 Historic marker, protect in place

7 New light pole, see lighting plans

8 Existing tree to be removed X

9 Existing owners improvements to remain. Remove and reset as necessary.

10 Prune back plants to remain along entire sidewalk edge.

Remove and treat all invasive plants with herbicides up to 6'-0" behind edge of ROW, especially in this area.

Replace in-kind any existing landscaping impacted in this area.

KEY	QUANTITY	SCIENTIFIC NAME	COMMON NAME	SIZE	SPACING	NOTES
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SHRUBS AN	D PERENNIALS				•	
AB	24	Agastache 'Blue Fortune'	Giant Hyssop	1 Gal	18" OC	
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WITH UPLIGHT (5.3)

EXISTING PLANTER AND — LANDMARK SIGN TO REMAIN

ADD (12) NFW AND (12) AB TO EXISTING PLANTER —

TO FILL IN PLANTING PER LANDSCAPE ARCHITECTS LAYOUT IN FIELD. ADD MULCH THROUGHOUT ENTIRE PLANTER.

TRANSPORTATION IMPROVEMENTS ALONG ROUTE 6A AND MILLWAY BARNSTABLE, MASSACHUSETTS

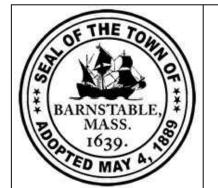
LANDSCAPE MATERIAL PLAN- 10

CONSTRUCTION DOCUMENTS

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SCALE: 1" = 5'



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#### LANDSCAPE NOTES:

#### **GENERAL:**

- . WHERE ANY DISCREPANCIES EXIST BETWEEN THE SPECIFICATIONS AND DRAWINGS, BRING TO THE ATTENTION OF THE LANDSCAPE ARCHITECT. THE MORE RESTRICTIVE SHALL GOVERN (WHICH SHALL BE DETERMINED BY THE LANDSCAPE ARCHITECT.)
- 2. FOR ALIGNMENTS, DIMENSIONS, ROADWAY, CURBS, CURB RAMPS, DETECTIBLE WARNING STRIPS, SIDEWALKS, CROSSWALKS, LIGHTING, DRAINAGE, AND GRADING, SEE ENGINEER'S
- 3. EXISTING UNDERGROUND UTILITIES ARE SHOWN PER AVAILABLE RECORDS FROM ENGINEER. VERIFY THE ACTUAL LOCATION AND ELEVATION IN THE FIELD PRIOR TO BEGINNING CONSTRUCTION. PROTECT EXISTING UTILITIES. CONSTRUCTOR SHALL BE RESPONSIBLE FOR DAMAGE TO UTILITIES ENCOUNTERED DURING CONSTRUCTION.
- 4. WHERE LANDSCAPE ARCHITECT'S APPROVAL IS REQUIRED, REQUEST APPROVAL AND OR INSPECTION A MINIMUM OF 14 BUSINESS DAYS IN ADVANCE. LANDSCAPE ARCHITECT MAINTAINS THE RIGHT TO REJECT WORK WHEN NOT IN CONFORMANCE WITH THE DRAWINGS OR SPECIFICATIONS.
- 5. MAKE ALL NECESSARY CONSTRUCTION NOTIFICATIONS AND APPLY FOR AND OBTAIN ALL NECESSARY CONSTRUCTION PERMITS, PAY ALL FEES INCLUDING POLICE DETAILS AND POST ALL BONDS, IF NECESSARY, ASSOCIATED WITH THE SAME, AND COORDINATE WITH THE OWNER AND THE ENGINEER.
- 6. UNLESS OTHERWISE INDICATED ON THE DRAWINGS AND/OR IN THE SPECIFICATIONS, ALL SITE CONSTRUCTION MATERIALS AND METHODOLOGIES ARE TO CONFORM TO THE MOST RECENT VERSION OF THE MASSACHUSETTS DEPARTMENT OF TRANSPORTATION STANDARD SPECIFICATION AND THE SPECIAL PROVISIONS PROVIDED.
- 7. RESTORE ALL ADJACENT SURFACES EQUAL TO THEIR ORIGINAL CONDITION AFTER CONSTRUCTION IS COMPLETE PER SPECIFICATIONS. LEAVE ALL AREAS NOT DISTURBED BY CONSTRUCTION IN THEIR NATURAL STATE. TAKE CARE TO PREVENT DAMAGE TO SHRUBS, TREES, OTHER LANDSCAPING AND/OR NATURAL FEATURES, BUILT WALLS, FENCES AND CURBS TO REMAIN. WHEREAS THE PLANS DO NOT SHOW ALL LANDSCAPE FEATURES, EXISTING CONDITIONS MUST BE VERIFIED BY THE CONTRACTOR IN ADVANCE OF THE WORK. LOAM AND SEED ALL DISTURBED LANDSCAPE AREAS, EVEN WHERE NOT EXPLICITLY CALLED OUT ON THE DRAWINGS.

#### **DEMOLITION AND REMOVALS:**

- 8. DEMOLITION SHALL CONSIST OF BOTH THE ITEMS NOTES IN THE ENGINEER'S AND LANDSCAPE ARCHITECT'S PLANS. BRING ANY DISCREPANCIES TO THE ATTENTION OF THE ENGINEER AND LANDSCAPE ARCHITECT
- 9. ALL TREES, HEDGES, FENCES AND OTHER SITE AMENITIES TO BE REMOVED OR RESET SHALL BE MARKED IN THE FIELD BY THE CONTRACTOR FOR APPROVAL BY THE OWNER'S REPRESENTATIVE PRIOR TO DEMOLITION. ANY OF THESE ITEMS, ESPECIALLY TREES, THAT ARE REMOVED WITHOUT PRIOR APPROVAL BY THE OWNERS REPRESENTATIVE SHALL BE THE RESPONSIBILITY OF THE CONTRACTOR.
- 10. CONTRACTOR SHALL CONFIRM THAT A TREE REMOVAL HEARING AND ALL NECESSARY TREE DEMOLITION PERMITS HAVE BEEN OBTAINED BY THE TOWN FOR EACH SPECIFIC TREE BEFORE IT IS REMOVED. ANY TREES REMOVED BY THE CONTRACTOR WITHOUT THE TREE REMOVAL PERMITS OBTAINED SHALL BE THE RESPONSIBILITY OF THE CONTRACTOR. THE TOWN SHALL BE RESPONSIBLE FOR OBTAINING THE NECESSARY PERMITS.
- 11. ALL FENCES AND WALLS WITHIN THE ROW THAT MUST BE REMOVED FOR CONSTRUCTION SHALL BE REMOVED, RETAINED, AND RESET AT THE BACK SIDE OF THE R.O.W. ALIGNMENT. THIS INCLUDES ALL ITEMS BOTH INDICATED AND NOT INDICATING IN THE DRAWINGS.

#### LANDSCAPE MATERIALS AND LAYOUT:

- 12. FOR ALL PAVING PATTERNS, CONTRACTOR SHALL PROVIDE SUBMITTALS, SAMPLES AND FULL MOCKUPS TO SPECIFICATION SIZES SHOWING THE PAVING PATTERN FOR LANDSCAPE ARCHITECTS APPROVAL PRIOR TO ORDERING ANY MATERIALS. COLOR SHALL BE SELECTED BY LANDSCAPE ARCHITECT IN THE FIELD WITH CONTRACTORS SAMPLES AND MOCKUPS ONCE THEY ARE PROVIDED. LANDSCAPE ARCHITECT RESERVES THE RIGHT TO ADJUST THE COLOR AND PATTERN ONCE THE MOCKUP HAS BEEN REVIEWED IN THE FIELD.
- 13. THE FULL LAYOUT OF ALL WALKWAYS, PLANTING BEDS, TREE LOCATIONS, CROSSWALKS AND OTHER ALIGNMENTS SHALL BE LAID OUT IN FIELD BY CONTRACTOR FOR LANDSCAPE ARCHITECTS REVIEW AND APPROVAL PRIOR TO CONSTRUCTION. ANY WORK CONSTRUCTED WITHOUT THE LAYOUT BEING REVIEWED BY THE LANDSCAPE ARCHITECT MAY BE REJECTED AND REQUIRED TO BE REBUILT AT THE CONTRACTOR'S EXPENSES.TREE LOCATIONS MAY BE SHIFTED DUE TO FIELD CONDITION.
- 14. INSTALL INTERSECTING ELEMENTS AT 90 DEGREE ANGLES TO EACH OTHER UNLESS OTHERWISE NOTED.
- 15. SAWCUT ALL WORK ADJACENT OR WITHIN EXISTING PAVEMENTS. BACKFILL AND COMPACT WORK AS INDICATED ON THE DRAWING AND IN THE SPECIFICATIONS. IF SETTLEMENT OCCURS DUE TO INADEQUATE COMPACTION, AS DETERMINED BY THE LANDSCAPE ARCHITECT, WITHIN THE WARRANTY PERIOD, CONTRACTOR IS REQUIRED TO REMOVE, PATCH AND REPAVE AFTER ONE COMPLETE 24-MONTH CYCLE.

#### PLANTING:

- 16. ALL NEW PLANT MATERIAL SHALL CONFORM TO THE MINIMUM GUIDELINES ESTABLISHED FOR NURSERY STOCK PUBLISHED BY THE AMERICAN NURSERY AND LANDSCAPE ASSOCIATION.
- 17. THE CONTRACTOR SHALL SUPPLY ALL NEW PLANT MATERIAL IN QUANTITIES SUFFICIENT TO COMPLETE THE PLANTING SHOWN ON THE DRAWINGS. WHERE DISCREPANCIES EXIST BETWEEN THE PLANT LIST AND THE GRAPHICS, THE HIGHER NUMBER SHALL GOVERN.
- 18. THE CONTRACTOR SHALL STAKE THE LOCATIONS OF ALL PROPOSED PLANTING FOR APPROVAL BY THE LANDSCAPE ARCHITECT PRIOR TO THE COMMENCEMENT OF PLANTING. ANY PLANTINGS INSTALLED WITHOUT APPROVAL BY THE LANDSCAPE ARCHITECT MAY BE REJECTED AND REQUIRED TO BE REINSTALLED WITH NEW PLANT MATERIALS THAT MEET THE SIZE AND SPECIFICATIONS AT THE CONTRACTOR'S EXPENSES.
- 19. ANY PROPOSED SUBSTITUTIONS OF PLANT SPECIES SHALL BE MADE WITH PLANTS OF EQUIVALENT OVERALL FORM, HEIGHT, BRANCHING HABIT, FLOWER, LEAF, COLOR, FRUIT, AND CULTURE ONLY AS APPROVED BY THE LANDSCAPE ARCHITECT.
- 20. WHERE ALL TREES ARE INDICATED, PROVIDE 24" DEEP OF CONTINUOUS NEW PLANTING SOIL IN A 48 SQUARE FOOT AREA AROUND THE ENTIRE TREE. PLANTING SOIL SHALL BE PER THE SPECIFICATIONS
- 21. APPLY MULCH IN ALL PLANTING BEDS AND AROUND ALL TREES FOR A 4' DIAMETER EXCEPT WHERE OTHERWISE CALLED OUT ON THE PLANS.
- 22. CONTRACTOR SHALL HIRE A CERTIFIED ARBORIST TO PRUNE AND DEEP ROOT FERTILIZE ALL EXISTING TREES TO REMAIN WITH ANY PORTION OF THEIR CANOPY WITHIN THE RIGHT OF WAY. THIS WORK SHALL BE COMPLETED AT THE END OF THE PROJECT. PRIOR TO SUBSTANTIAL COMPLETION.

#### **LANDSCAPE MAINTENANCE NOTES:**

THE CONTRACTOR SHALL PROVIDE 1 YEAR OF FULL LANDSCAPE MAINTENANCE (MAINTENANCE PERIOD) FOR THE ENTIRE LANDSCAPE SCOPE OF THE PROJECT FROM DATE OF SUBSTANTIAL COMPLETION AS PART OF THE BASE BID OF THIS PROJECT. IN ADDITION, THE CONTRACTOR SHALL PROVIDE A TWO-YEAR ESTABLISHMENT (WARRANTY) PERIOD FROM SUBSTANTIAL COMPLETION (EQUAL TO AN ADDITIONAL YEAR PAST THE MAINTENANCE PERIOD) FOR ALL ITEMS SHOW ON THE LANDSCAPE SHEETS. LANDSCAPE MAINTENANCE SHALL INCLUDE THE FOLLOWING:

- 1. CULTIVATION AND WEEDING PLANT BEDS. ALL PLANTED AREAS MUST REMAIN WEED FREE AT ALL TIMES.
- 2. WATER ALL TREES, PLANTINGS AND SEED AREAS FOR ESTABLISHMENT AND IN TIMES OF DROUGHT. CONTRACTOR IS RESPONSIBLE FOR PROVIDING WATER TO SITE. DURING FIRST YEAR OF PLANT ESTABLISHMENT, CHECK FOR MOISTURE PENETRATION THROUGHOUT ROOT ZONE TO 6" AT LEAST ONCE A MONTH. FILL SLOW RELEASE TREE WATERING BAGS. ADJUST SUPPLEMENTAL WATERING AS REQUIRED.
- 3. PRUNING, INCLUDING REMOVAL OF DEAD OR BROKEN BRANCHES.
- 4. SOIL TESTS- PROVIDE A SOIL TESTS FOR A PLANTING AND LAWN AREAS 6 MONTHS INTO MAINTENANCE CONTRACT. CONTRACTOR IS REQUIRED TO APPLY ORGANIC FERTILIZER AND ADJUST PH WITH AMENDMENTS FOR ALL LAWNS, TREES AND PLANTING BEDS AFTER SOIL TEST AT RATES PER SOIL TEST RECOMMENDATIONS FOR THOSE TYPES OF PLANTINGS. SUBMIT TEST RESULTS AND AMENDMENT PLAN FOR LANDSCAPE ARCHITECTS APPROVAL PRIOR TO COMPLETING.
- 5. APPLY DISEASE AND INSECT CONTROL ONLY IF REQUIRED AND WITH LANDSCAPE ARCHITECT'S PERMISSION. ONLY ORGANIC PRODUCTS ARE PERMITTED UNLESS OTHERWISE APPROVED BY THE LANDSCAPE ARCHITECT
- 6. REPLACEMENT OF MULCH.
- 7. REMOVAL OF TRASH WITHIN ALL NEW PLANTING AREAS AND LAWNS. SWEEP ALL SIDEWALK AREAS TO KEEP CLEAN AND NEAT.
- 8. LAWN AREAS SHOULD BE MOWED TO 3" HEIGHT ABOVE FINISHED GRADE IN ORDER TO RENEW GROWTH, IMPROVE DENSITY AND ATTRACTIVENESS. SUBMIT SUGGESTED MOWING SCHEDULE TO LANDSCAPE ARCHITECT FOR APPROVAL PRIOR TO MOWING. TRIM EDGES AS NEEDED FOR NEAT APPEARANCE.
- 9. APPLY A SLOW RELEASE ORGANIC FERTILIZER ONCE IN SPRING AND AGAIN IN THE FALL TO ALL LAWN AREAS AT RATES ACCORDING TO MANUFACTURER'S RECOMMENDATIONS. APPLY FERTILIZER WHEN GRASS IS DRY AND PREFERABLY AFTER MOWING. DO NOT APPLY DURING HOT WEATHER OR WHEN GRASS IS UNDER STRESS. WATER IMMEDIATELY AFTER APPLICATION.
- 10. DISPOSE OF PRUNED MATERIALS, EXCESSIVE LAWN CLIPPINGS AND LEAVES, SWEEP WALKWAYS AND RAKE SMOOTH MULCHED AREAS. ALL SPRING AND FALL CLEANUPS MUST BE DONE IN A TIMELY MANNER TO KEEP THE LANDSCAPE AREAS FREE OF LEAVES AND NATURAL DEBRIS. REMOVE FROM SITE BAGS OF LEAVES, TRASH AND EVIDENCE OF MAINTENANCE ACTIVITIES AT THE END OF EACH MAINTENANCE VISIT.

#### ADD ALTERNATE 1-WAYFINDING SIGNAGE NOTES:

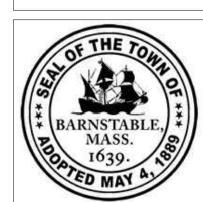
AN ADD ALTERNATE PRICE SHALL BE PROVIDED FOR THE DESIGN AND CONSTRUCTION OF A SIGNAGE SYSTEM AS INDICATED IN THE DRAWINGS. LOCATIONS FOR THE SIGNS AND GENERAL DESIGN INTENT IS INDICATED. CONTRACTOR IS RESPONSIBLE FOR DESIGNING THE FULL DETAILS OF THE SIGNAGE SYSTEM, INCLUDING BUT NOT LIMITED TO FOUNDATIONS, STRUCTURAL SUPPORTS, AND ALL SIGNAGE ELEMENTS. CONTRACTOR SHALL SUBMIT SHOW DRAWINGS SHOWING ALL ELEMENTS OF THE SIGNAGE DESIGN TO THE LANDSCAPE ARCHITECT AND OWNER'S REPRESENTATIVE FOR APPROVAL. OWNER'S REPRESENTATIVE AND LANDSCAPE ARCHITECT RESERVE THE RIGHT TO MAKE CHANGES TO THE SHOP DRAWINGS TO REFLECT THE DESIRED HISTORIC DESIGN INTENT. EXACT CONTENT OF EACH SIGN WILL BE PROVIDED BY THE TOWN DURING THE SHOP DRAWING PROCESS.

GENERAL DETAILS INDICATING BASIC INTENT FOR THE PROPOSED SIGNS ARE INCLUDED IN THE DRAWING SET.

THE FOLLOWING SHALL BE ASSUMED AND INCLUDED IN THE SIGNAGE ELEMENTS:

- 1. ALL TEXT ON PEDESTRIAN WAYFINDING SIGNS SHALL BE A MINIMUM OF 3" HEIGHT.
- 2. ALL TEXT ON THE VEHICULAR WAYFINDING SIGNS (REGIONAL DISTRICT SIGNS AND PARKING SIGNS) SHALL BE A MINIMUM 6" HEIGHT.
- 3. MATERIALS FOR THE SIGNS SHALL BE CARVED HIGH DENSITY URETHANE FOAM (HDU), OFF-WHITE BACKGROUND (FINISH OF ALL POSTS AND SIGNS TO MATCH) WITH BLACK LETTERS. EXACT SHADES OF WHITE AND BLACK SHALL BE DETERMINED FROM COLOR SAMPLES. POST SHALL BE PRESSURE TREATED WOOD (WITHOUT BLEMISHES, KNOTS, OR ROUGH SURFACES), PRIMED AND PAINTED WHITE.
- 4. ALL STRUCTURAL ENGINEERING OF THE SIGNS, FOUNDATIONS, ATTACHMENTS, AND INSTALLATION DETAILS IS THE RESPONSIBILITY OF THE CONTRACTOR.
- 5. ALL POSTS SHALL BE DIRECT BURIED INTO THE GROUND, AT NECESSARY DEPTHS AND INSTALLATION DETAILS AS DETERMINED BY THE SIGN MANUFACTURER AND STRUCTURAL ENGINEER.
- 6. CONTRACTOR SHALL PROVIDE A TEN YEAR WARRANTY ON BOTH THE INSTALLATION AND MATERIALS OF ALL SIGNAGE FLEMENTS







			Scale	AS NOTED
			Date	OCTOBER 2018
			Job No.	271-1607
03	10/19/18	REVISED FINAL SUBMISSION	Designed by	KK & SCH
02	08/22/18	FINAL SUBMISSION	Drawn by	SCH & EH
01	08/01/18	DRAFT PRELIMINARY DESIGN SUBMISSION	Checked by	KK
MAF	RK DATE	DESCRIPTION	Approved by	KK

HIS LINE IS ONE INCH \_\_\_\_\_ ONG WHEN PLOTTED T FULL SCALE ON A 22" X 34" DRAWING TRANSPORTATION IMPROVEMENTS ALONG ROUTE 6A AND MILLWAY BARNSTABLE, MASSACHUSETTS

CONSTRUCTION DOCUMENTS

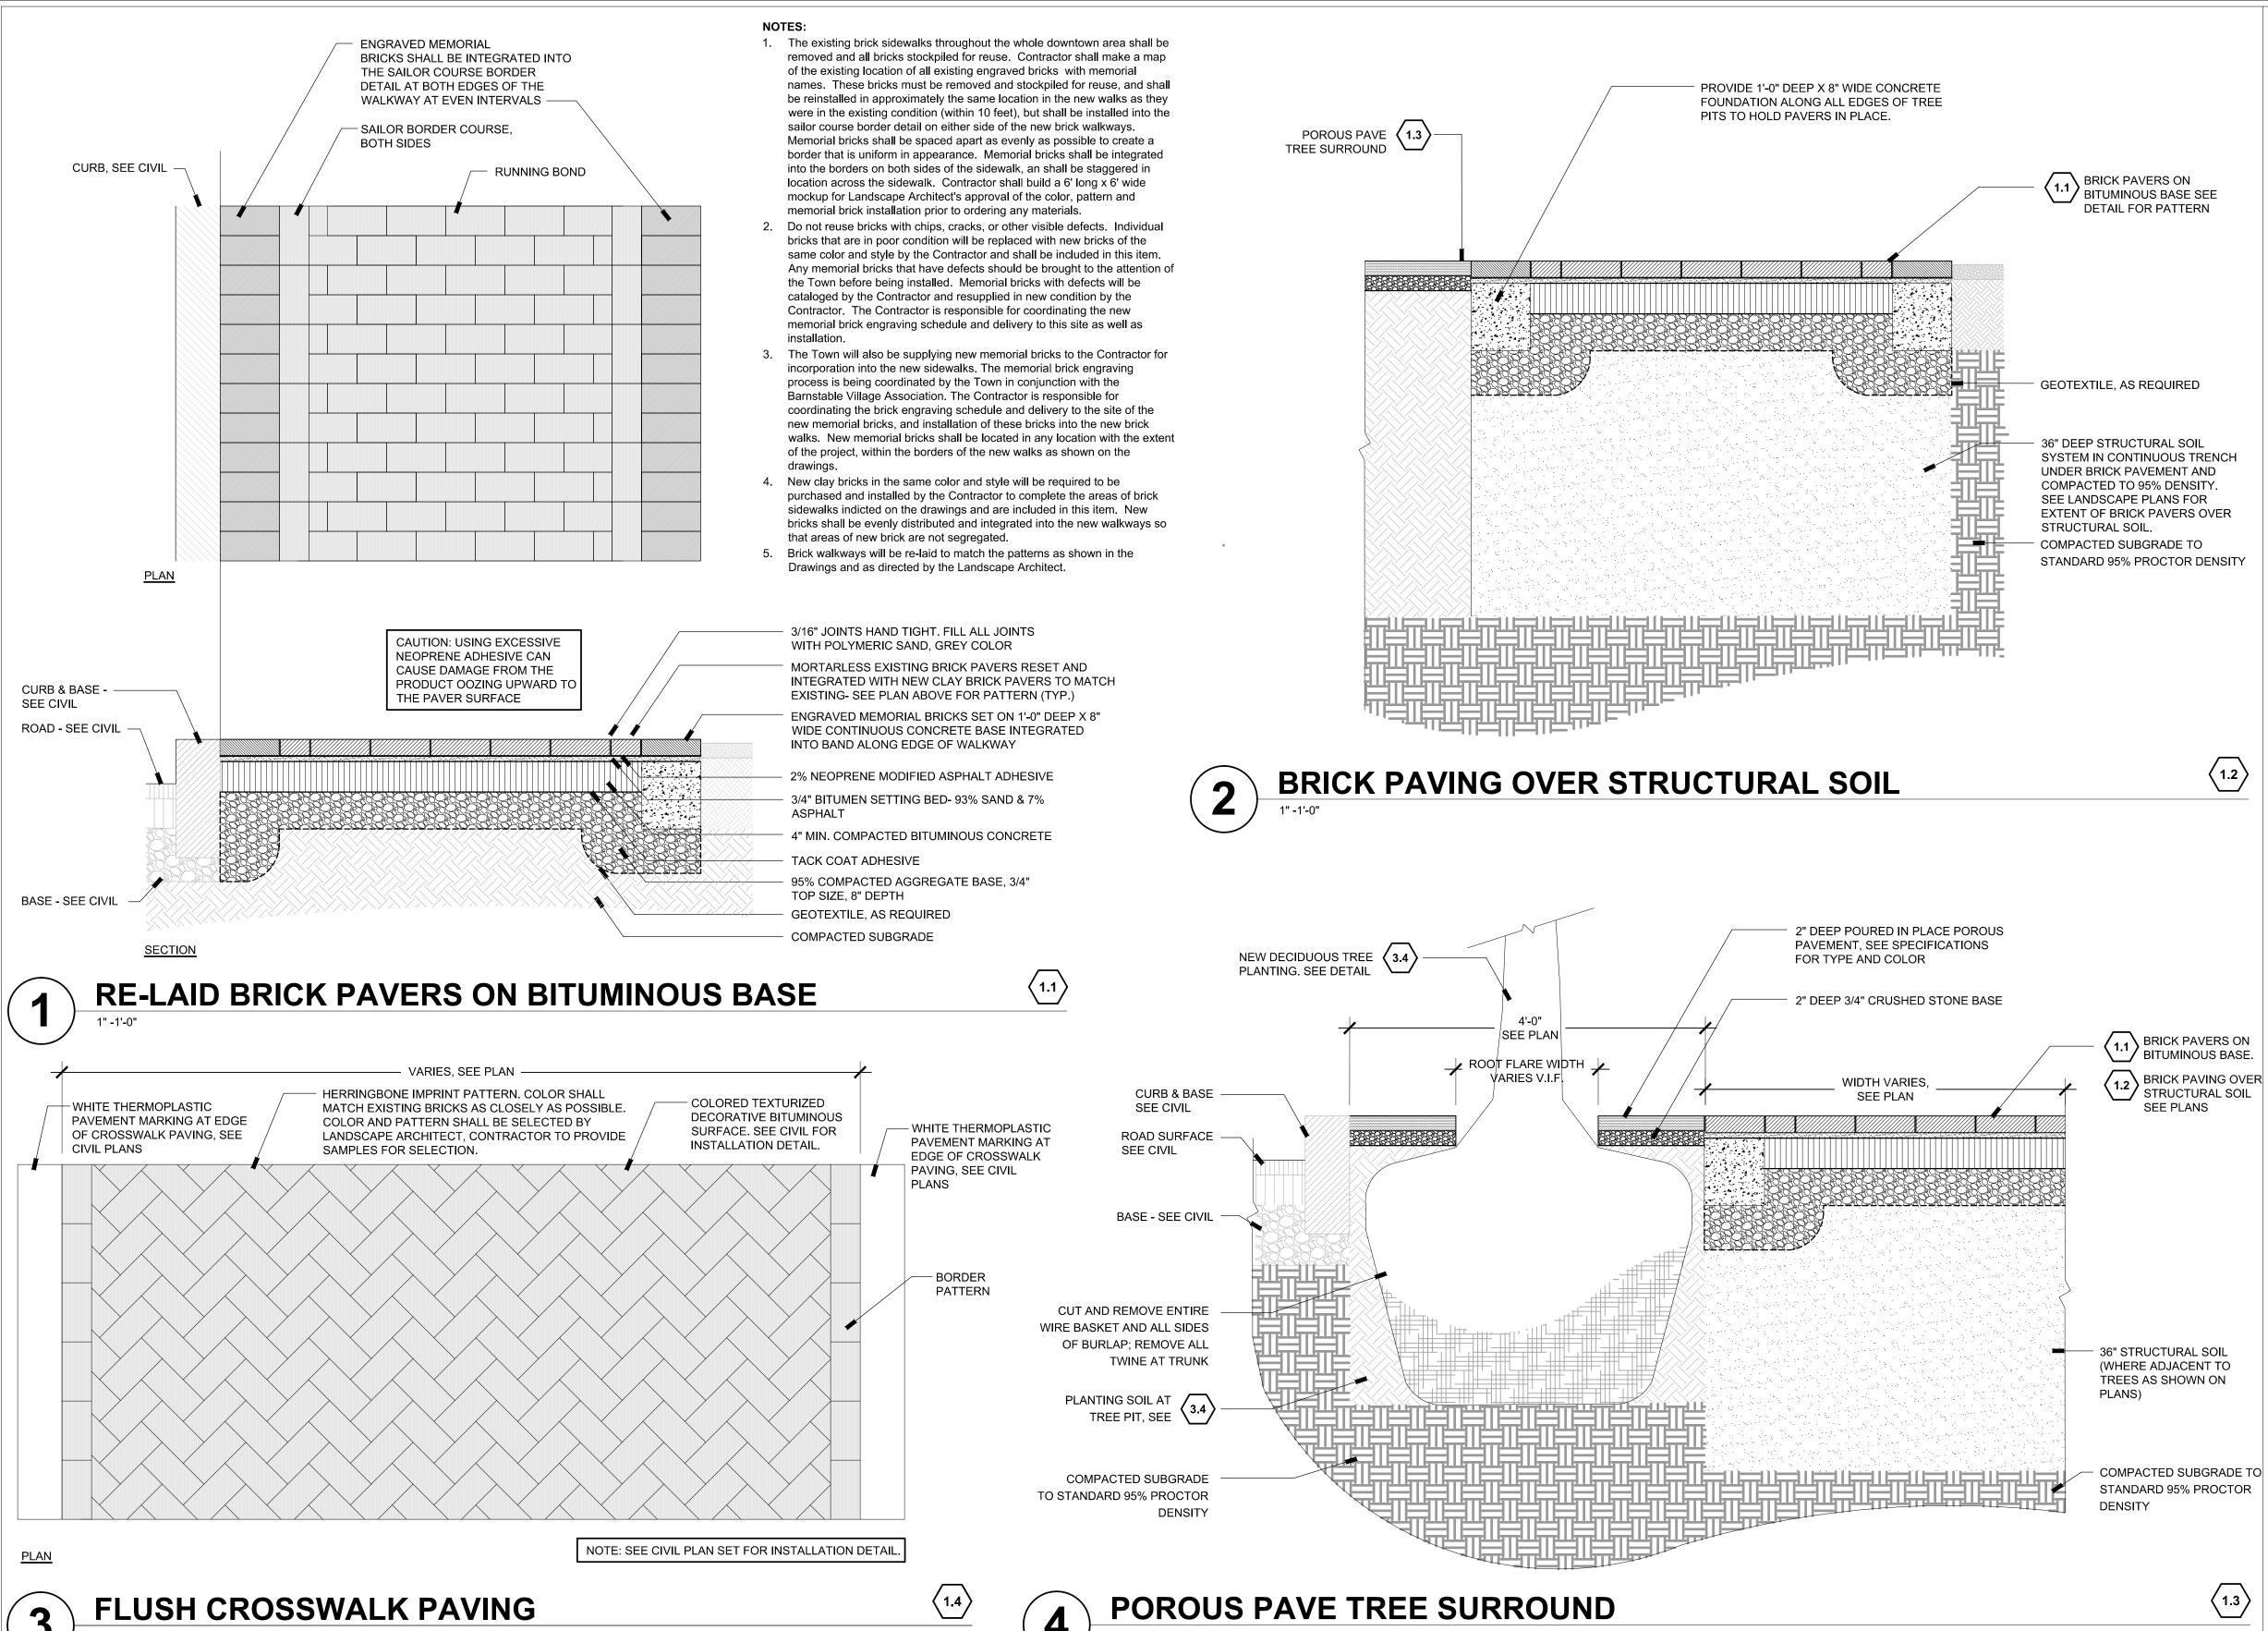
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Sheet No.

85

LANDSCAPE NOTES



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MASS.

547 rutherford ave. | charlestown, ma | 02129 p 617.500.6530 f 617.500.6531 www.offshootsinc.com AS NOTED TRANSPORTATION IMPROVEMENTS CONSTRUCTION DOCUMENTS Scale Date OCTOBER 2018 ALONG ROUTE 6A AND MILLWAY Sheet No. Job No. 271-1607 BARNSTABLE, MASSACHUSETTS HIS LINE IS ONE INCH 03 | 10/19/18 | REVISED FINAL SUBMISSION KK & SCH Designed by LONG WHEN PLOTTED SCH & EH 02 08/22/18 FINAL SUBMISSION Drawn by AT FULL SCALE ON A LANDSCAPE DETAILS: 22" X 34" DRAWING 01 | 08/01/18 | DRAFT PRELIMINARY DESIGN SUBMISSION Checked by PAVING- 01 MARK DATE DESCRIPTION Approved by

LANDSCAPE DETAIL KEYNOTES: DETAIL/SHEET

RE-LAID BRICK PAVERS ON BITUMINOUS BASE

BRICK PAVING OVER STRUCTURAL SOIL

1.3 FFFF POROUS PAVE TREE SURROUND

INTERSECTION PAVING

FLUSH CROSSWALK PAVING

RAISED CROSSWALK PAVING

1/86

2/86

4/86

3/86

1/ 87

2/87

1/ 89

2/89

3/89

4/ 89

5/ 89

1/ 88

2/ 88

3/ 88

4/ 88

1/ 90

2/ 90

3/ 90

**PAVEMENT** 

SITE LIGHTING

**PLANTING** 

SEE ENGINEERS DRAWINGS

SITE FURNISHING

LOAM AND SEED

NEW SHRUB PLANTING

( · ) NEW EVERGREEN TREE

BENCH- 5 TOTAL

FLAGPOLE- 1 TOTAL

**BIKE RACK-3 TOTAL** 

SIGNAGE- ADD ALTERNATE #1

PERENNIAL PLANTING

**NEW DECIDUOUS TREE** 

TRASH RECEPTACLE- 4 TOTAL

DISTRICT ENTRY SIGN- ADD ALTERNATE #1- 2 TOTAL

PARKING SIGN- ADD ALTERNATE #1- 2 TOTAL

PEDESTRIAN SIGN- ADD ALTERNATE #1- 5 TOTAL

1.5

1.6

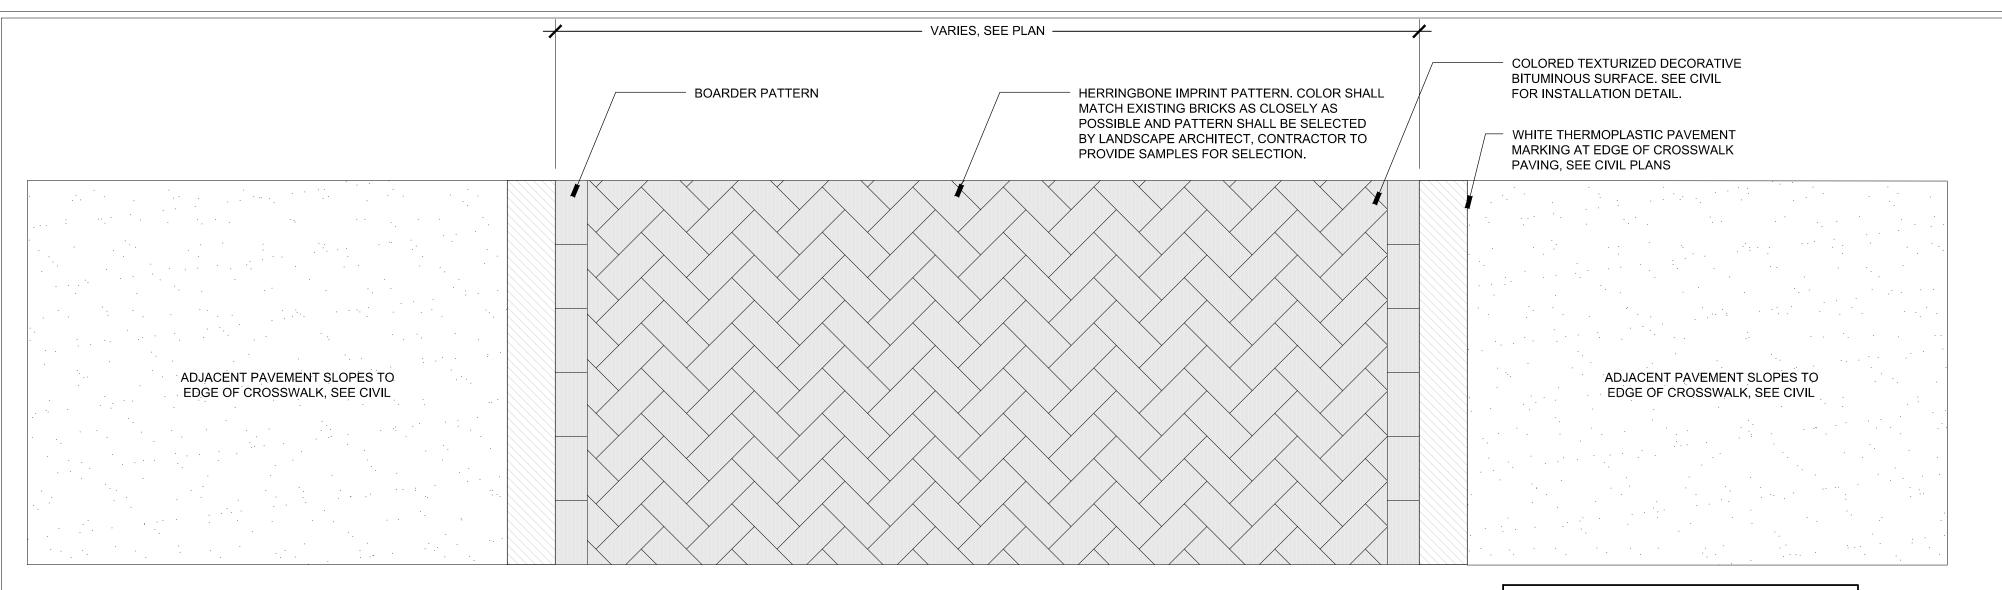
3.2

3.3

5.2

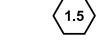
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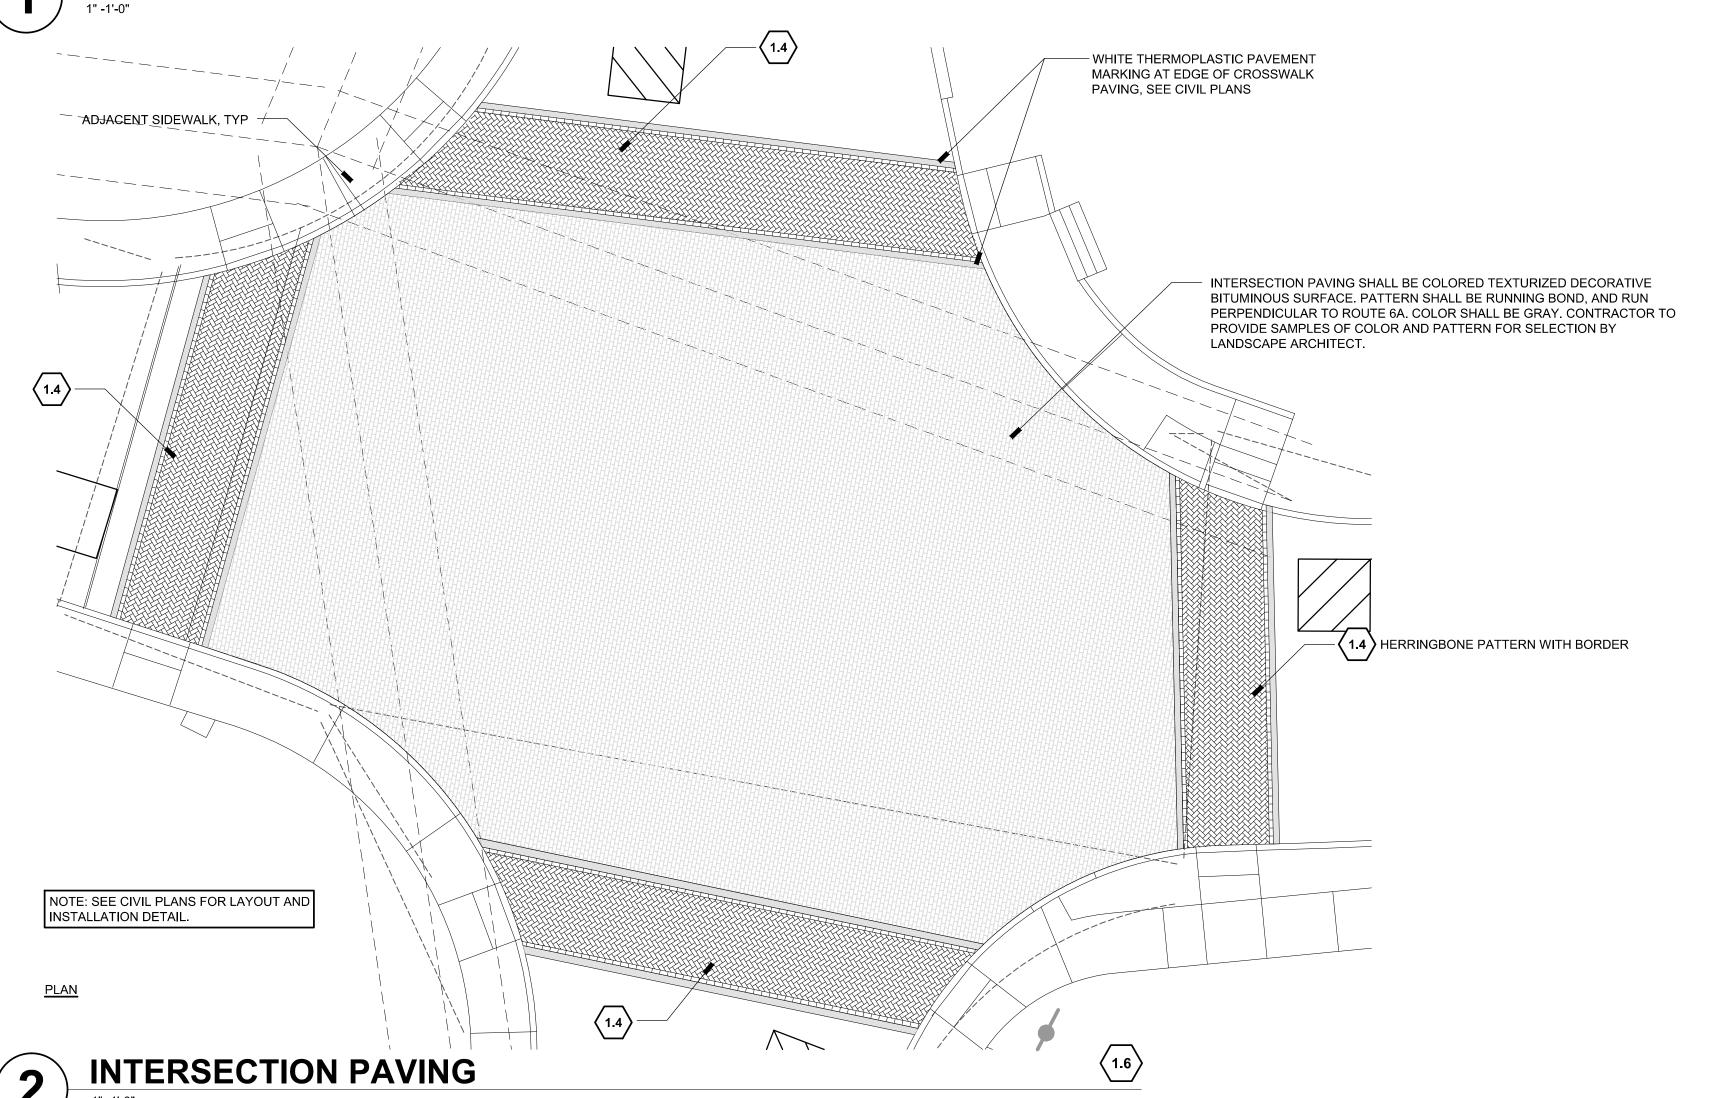
5.5



NOTE: SEE CIVIL PLAN SET FOR INSTALLATION DETAIL.







LANDSCAPE DETAIL KEYNOTES: DETAIL/SHEET

**PAVEMENT** 

RE-LAID BRICK PAVERS ON BITUMINOUS BASE 1/ 86 BRICK PAVING OVER STRUCTURAL SOIL 2/ 86 1.3 FFFF POROUS PAVE TREE SURROUND 4/ 86 3/86 FLUSH CROSSWALK PAVING 1/ 87 RAISED CROSSWALK PAVING INTERSECTION PAVING 2/ 87

SITE LIGHTING

SEE ENGINEERS DRAWINGS

**PLANTING** 

3.1 LOAM AND SEED 1/ 89 3.2 PERENNIAL PLANTING 2/ 89 3.3 NEW SHRUB PLANTING 3/ 89 NEW DECIDUOUS TREE 4/ 89 3.5 ( ) NEW EVERGREEN TREE 5/ 89

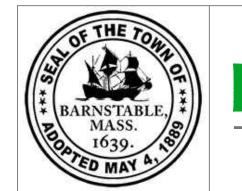
SITE FURNISHING

5.1	BENCH- 5 TOTAL	1/ 88
5.2	TRASH RECEPTACLE- 4 TOTAL	2/ 88
5.3	FLAGPOLE- 1 TOTAL	3/ 88
5.5	BIKE RACK- 3 TOTAL	4/ 88

SIGNAGE- ADD ALTERNATE #1

DISTRICT ENTRY SIGN- ADD ALTERNATE #1- 2 TOTAL 6.2 PARKING SIGN- ADD ALTERNATE #1- 2 TOTAL 2/ 90 PEDESTRIAN SIGN- ADD ALTERNATE #1- 5 TOTAL 3/90

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<u>PLAN</u>

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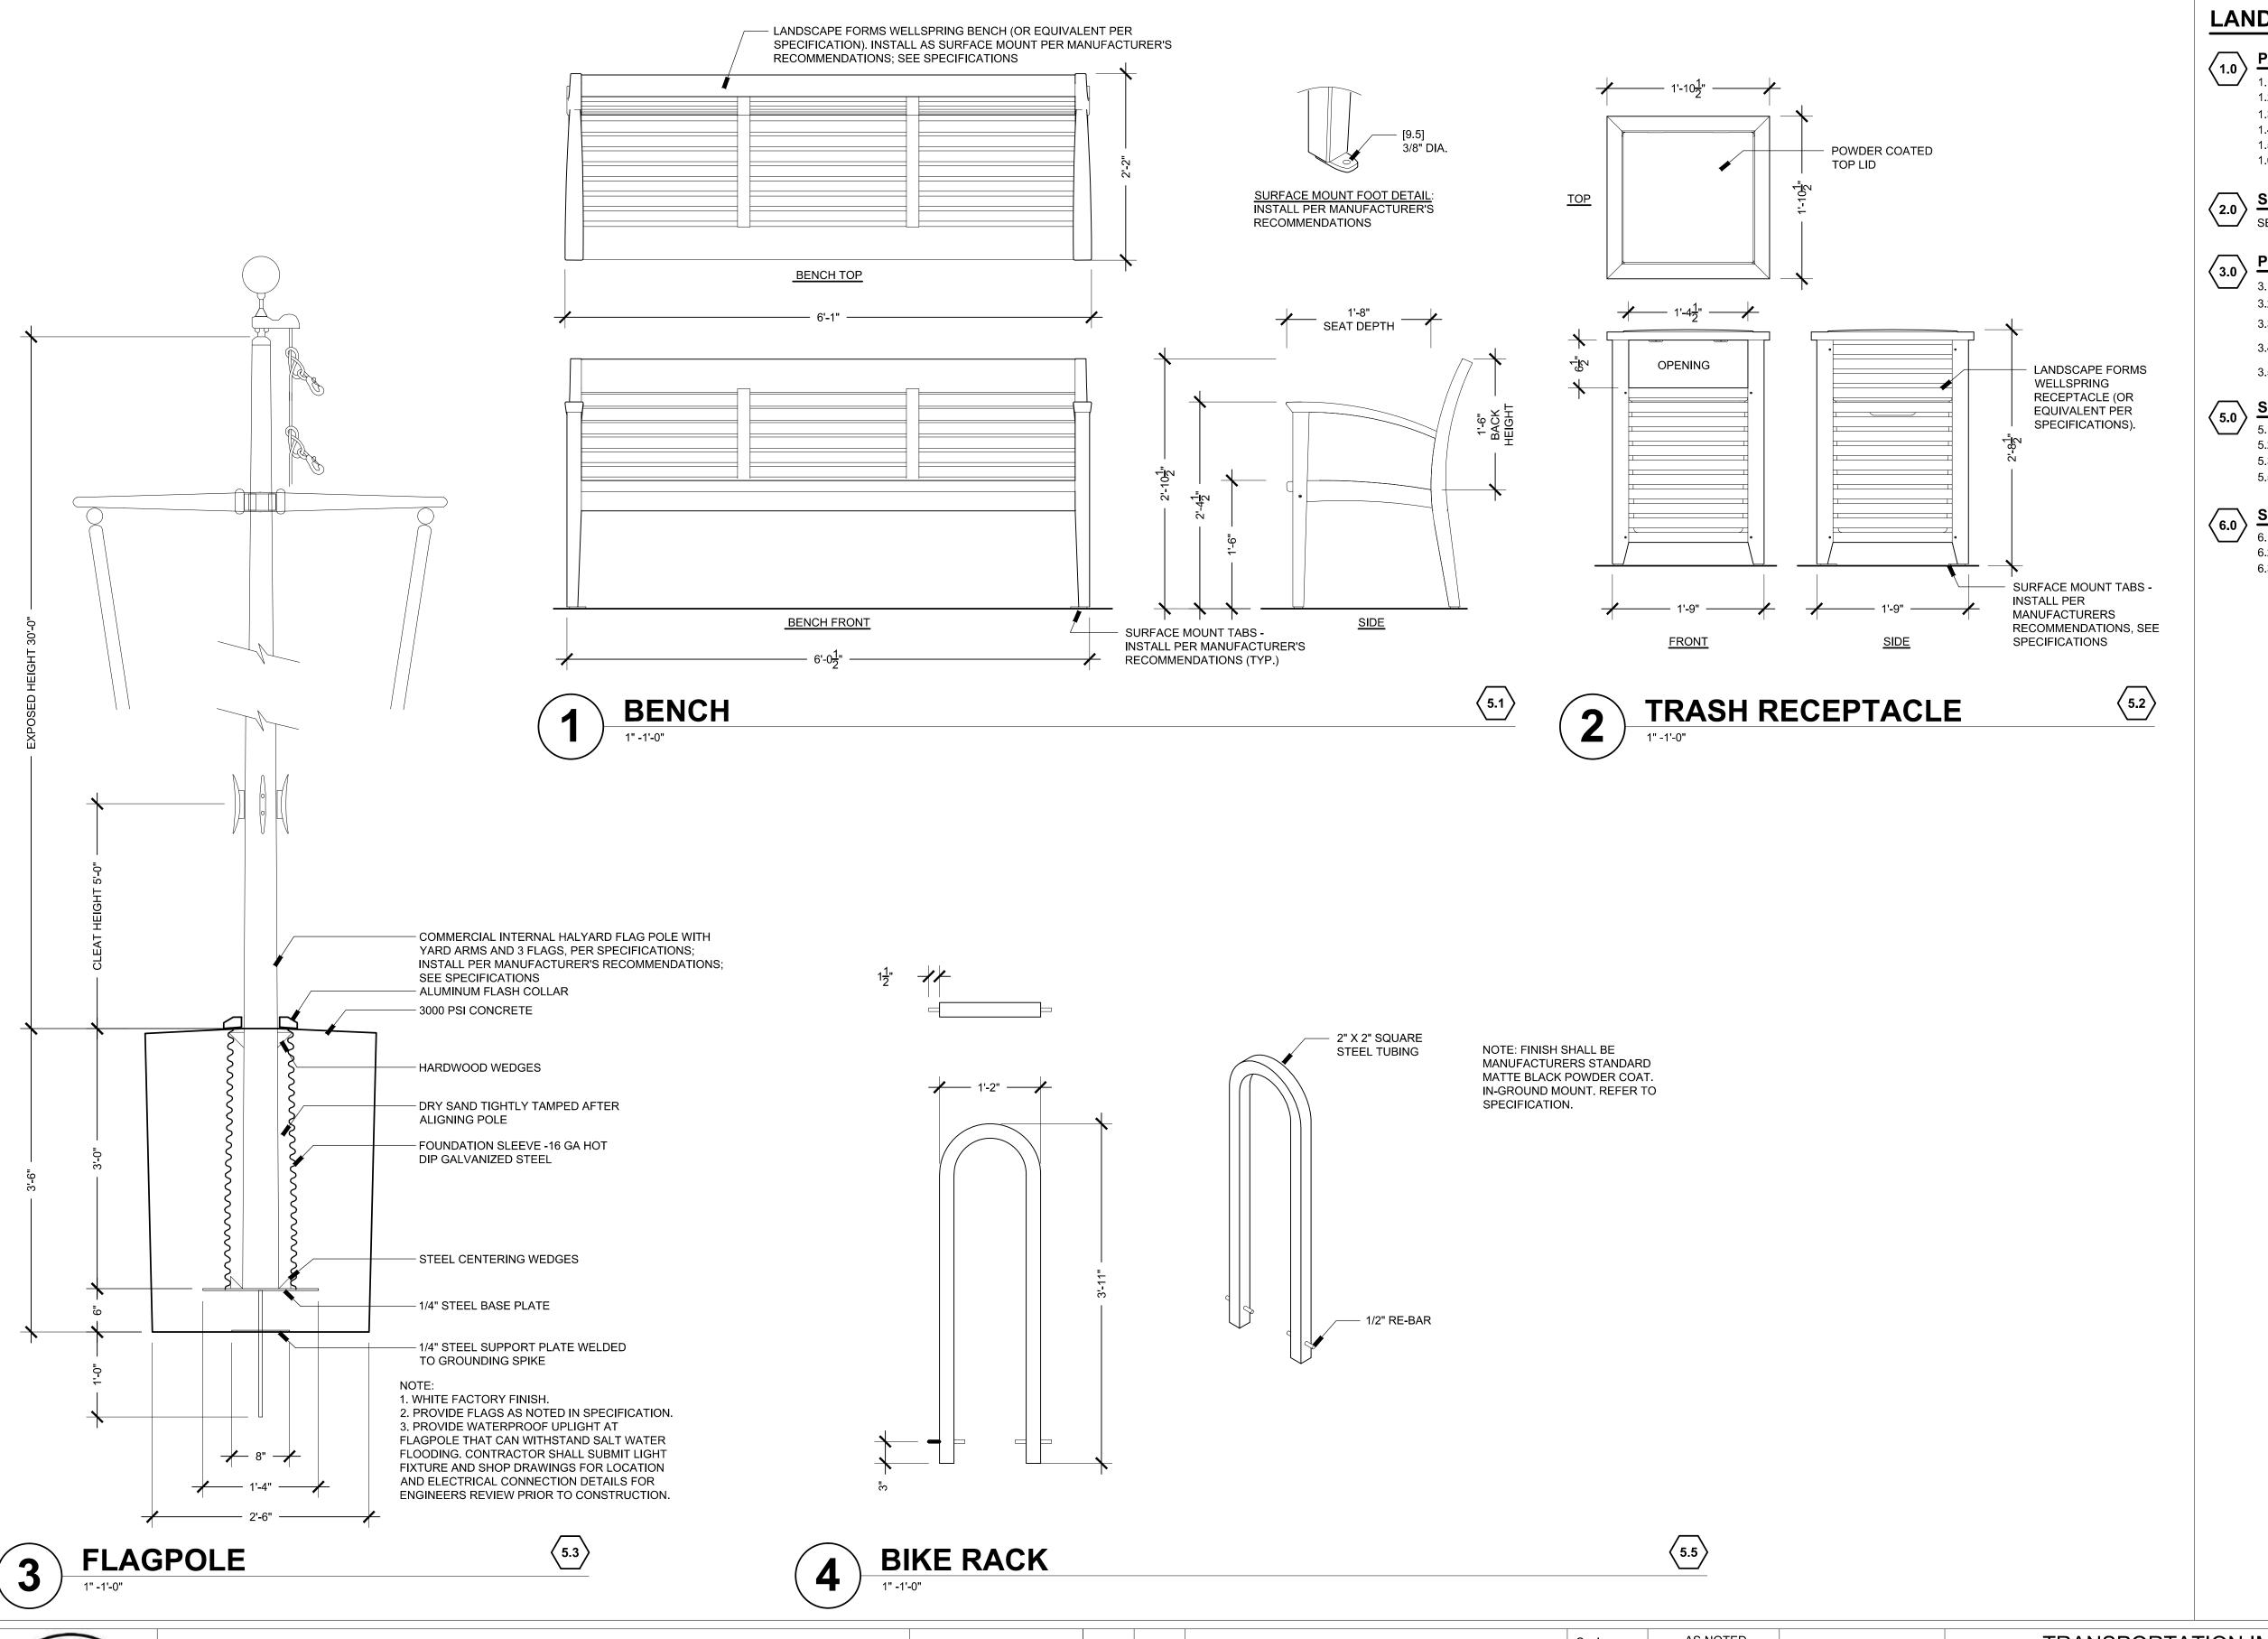
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			Date	OCTOBER 2018	
			Job No.	271-1607	
03	10/19/18	REVISED FINAL SUBMISSION	Designed by	KK & SCH	_ T⊦ _ L
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01	08/01/18	DRAFT PRELIMINARY DESIGN SUBMISSION	Checked by	KK	
MARK	DATE	DESCRIPTION	Approved by	KK	

S LINE IS ONE INCH ONG WHEN PLOTTED F FULL SCALE ON A 22" X 34" DRAWING

TRANSPORTATION IMPROVEMENTS ALONG ROUTE 6A AND MILLWAY BARNSTABLE, MASSACHUSETTS

> LANDSCAPE DETAILS: PAVING- 02

CONSTRUCTION DOCUMENTS





RE-LAID BRICK PAVERS ON BITUMINOUS BASE 1/86 1.2 BRICK PAVING OVER STRUCTURAL SOIL 2/86 1.3 FFFF POROUS PAVE TREE SURROUND 4/ 86 FLUSH CROSSWALK PAVING 3/ 86 RAISED CROSSWALK PAVING 1/87 INTERSECTION PAVING 2/ 87

2.0 SITE LIGHTING
SEE ENGINEERS DRAWINGS

3.1 LOAM AND SEED 1/ 89 PERENNIAL PLANTING 3.2 2/ 89 3.3 ( NEW SHRUB PLANTING 3/89 3.4 (+) NEW DECIDUOUS TREE 3.5 NEW EVERGREEN TREE 5/ 89

SITE FURNISHING

 5.1	BENCH- 5 TOTAL	1/ 88
5.2	TRASH RECEPTACLE- 4 TOTAL	2/ 88
5.3	FLAGPOLE- 1 TOTAL	3/ 88
5.5	BIKE RACK- 3 TOTAL	4/ 88

SIGNAGE- ADD ALTERNATE #1

6.1	DISTRICT ENTRY SIGN- ADD ALTERNATE #1- 2 TOTAL	1/ 90
6.2	PARKING SIGN- ADD ALTERNATE #1-2 TOTAL	2/ 90
6.3	PEDESTRIAN SIGN- ADD ALTERNATE #1- 5 TOTAL	3/ 90

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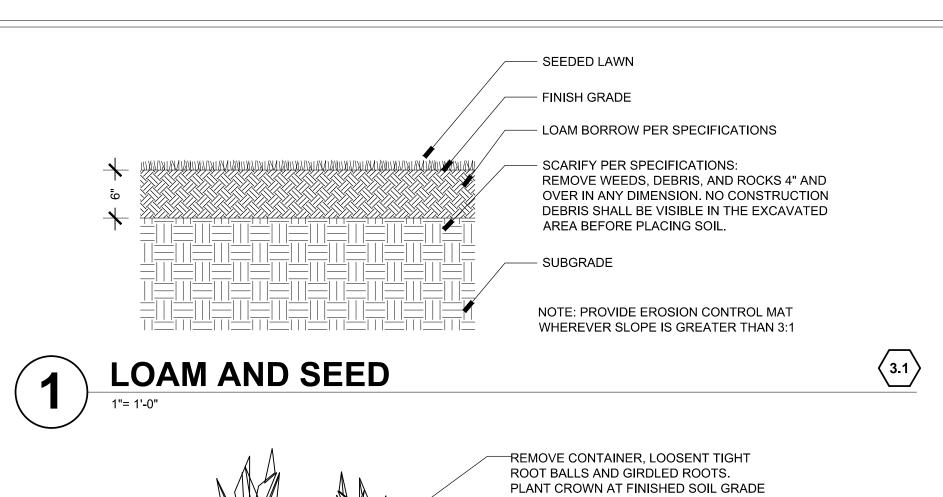


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01	08/01/18	DRAFT PRELIMINARY DESIGN SUBMISSION	Checked by	KK	22" X 34" DRAWING
MARK	DATE	DESCRIPTION	Approved by	KK	

TRANSPORTATION IMPROVEMENTS ALONG ROUTE 6A AND MILLWAY BARNSTABLE, MASSACHUSETTS

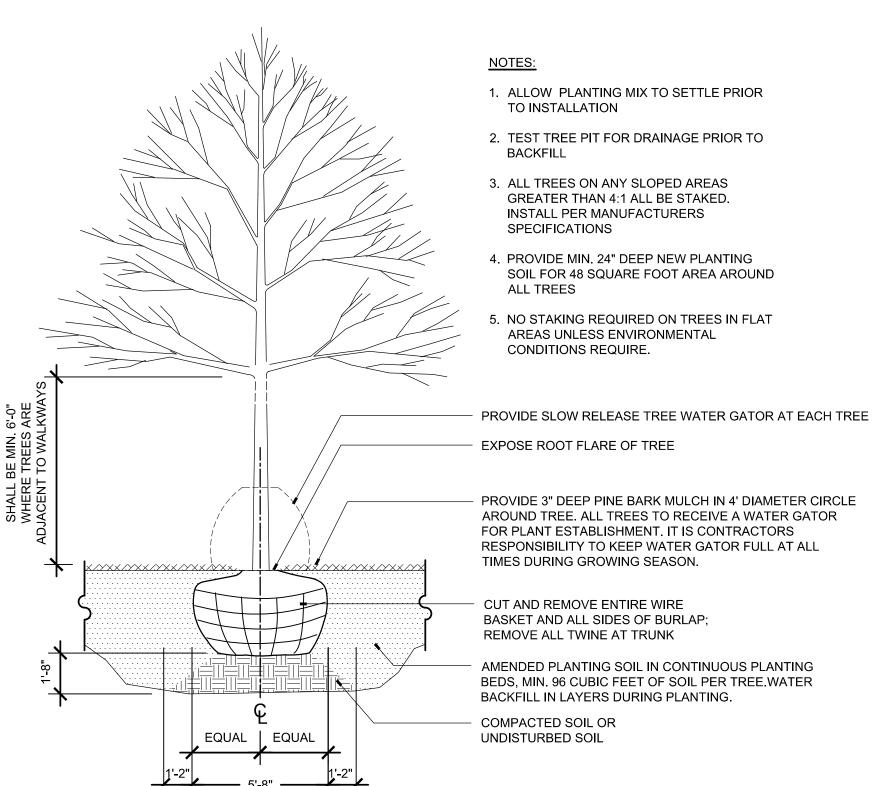
> LANDSCAPE DETAILS: FURNITURE- 03

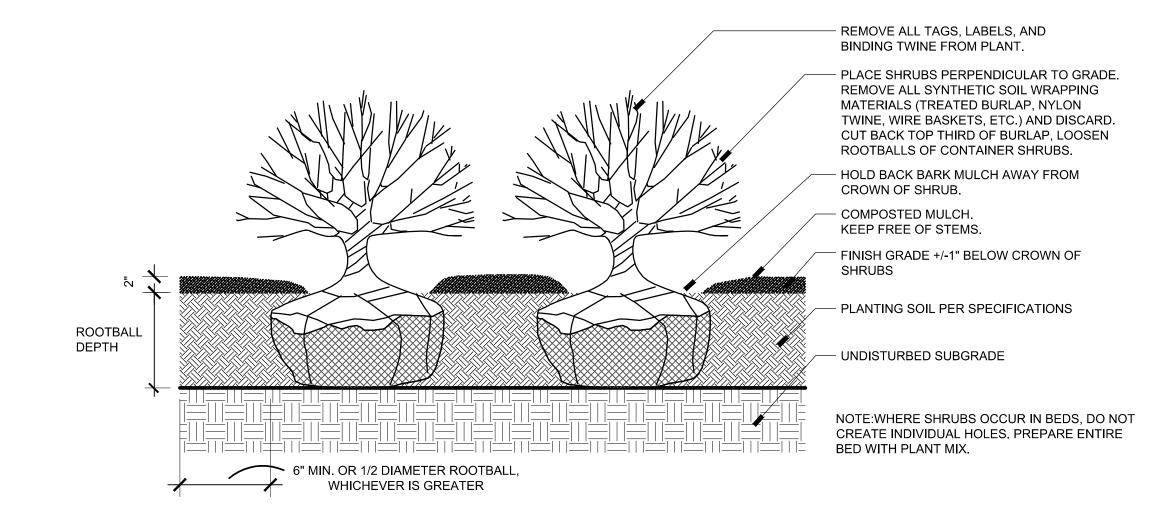
CONSTRUCTION DOCUMENTS Sheet No.



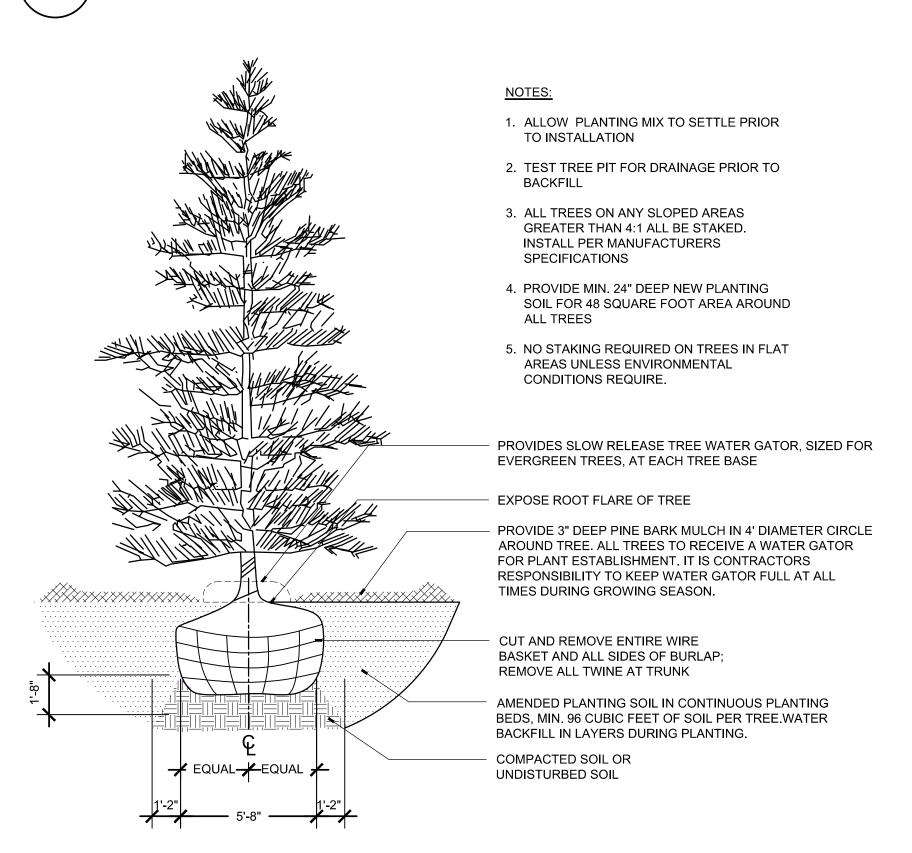
3" DEPTH AGED PINE BARK MULCH. KEEP FREE OF STEMS. PLANTING SOIL PER SPECIFICATIONS - UNDISTURBED SUBGRADE NOTE:SEE PLANT LIST FOR SPACING. LOCATIONS OF PLANT MATERIALS TO BE APPROVED BY LANDSCAPE ARCHITECT IN FIELD PRIOR TO PLANTING

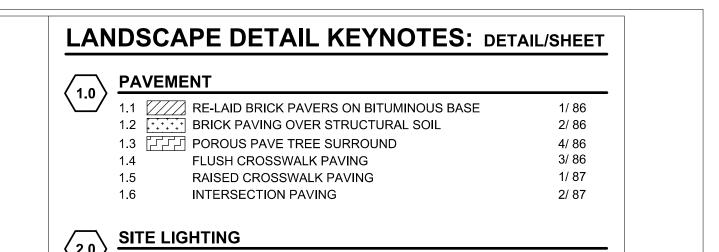
3.2 PERENNIAL PLANTING





3.3





LOAM AND SEED 1/ 89 PERENNIAL PLANTING 3.2 2/ 89 3.3 ( NEW SHRUB PLANTING 3/89 3.4 (+) NEW DECIDUOUS TREE 3.5 ( ) NEW EVERGREEN TREE 5/ 89

SITE FURNISHING

SEE ENGINEERS DRAWINGS

\	SIIL	SITE FORMSHING					
/	5.1	BENCH- 5 TOTAL	1/ 88				
	5.2	TRASH RECEPTACLE- 4 TOTAL	2/ 88				
	5.3	FLAGPOLE- 1 TOTAL	3/ 88				
	5.5	BIKE RACK- 3 TOTAL	4/ 88				

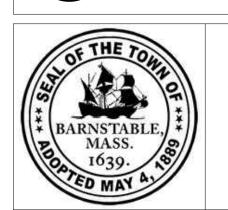
SIGNAGE- ADD ALTERNATE #1

6.1	DISTRICT ENTRY SIGN- ADD ALTERNATE #1- 2 TOTAL	1/ 90
6.2	PARKING SIGN- ADD ALTERNATE #1- 2 TOTAL	2/90
6.3	PEDESTRIAN SIGN- ADD ALTERNATE #1- 5 TOTAL	3/ 90
		6.2 PARKING SIGN- ADD ALTERNATE #1- 2 TOTAL

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**NEW EVERGREEN TREE** 5

**SHRUB PLANTING** 



**NEW DECIDOUS TREE** 

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3.4

				Scale	AS NOTED	
				Date	OCTOBER 2018	
				Job No.	271-1607	
	03	10/19/18	REVISED FINAL SUBMISSION	Designed by	KK & SCH	THIS LINE IS ONE INCH LONG WHEN PLOTTED
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	01	08/01/18	DRAFT PRELIMINARY DESIGN SUBMISSION	Checked by	KK	22" X 34" DRAWING
ı	MARK	DATE	DESCRIPTION	Approved by	KK	

3.5

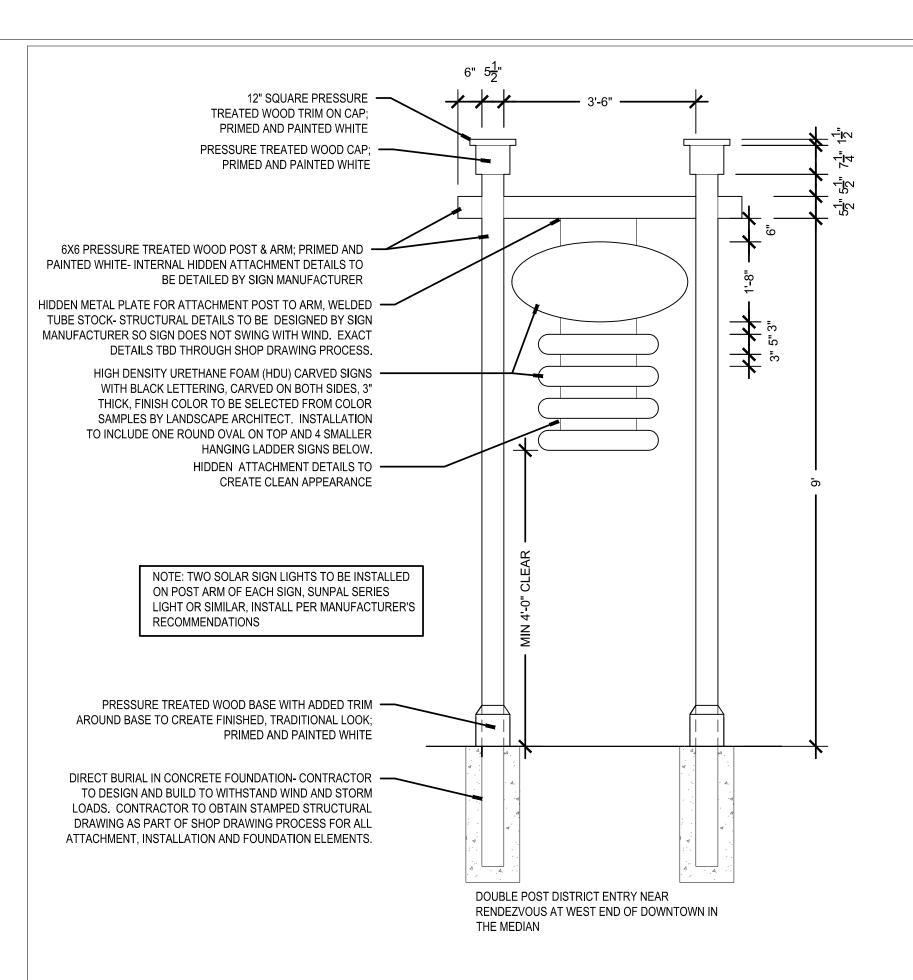
TRANSPORTATION IMPROVEMENTS ALONG ROUTE 6A AND MILLWAY BARNSTABLE, MASSACHUSETTS

> LANDSCAPE DETAILS: PLANTING-04

CONSTRUCTION DOCUMENTS

Sheet No.

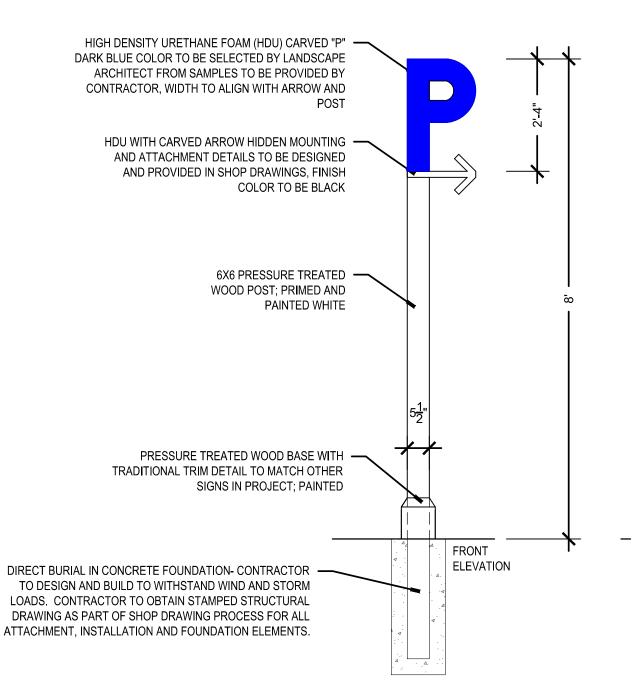
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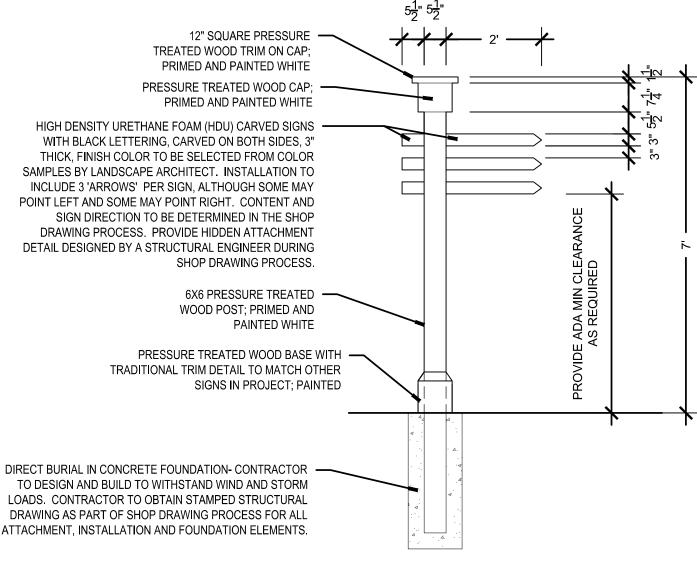


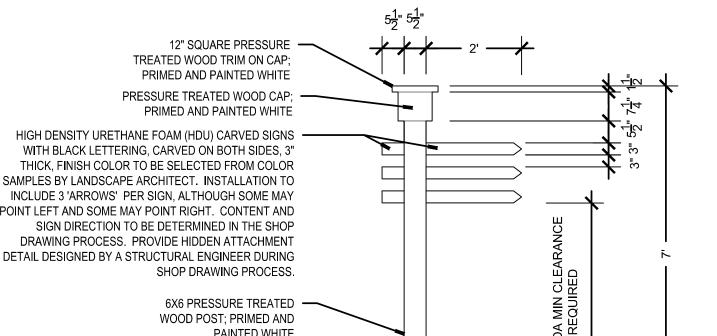


CONTRACTOR TO DESIGN, MANUFACTURE AND INSTALL SIGNS THAT MIMIC THE APPEARANCE OF THE SIGN IN THE ABOVE PHOTO. THE BACKGROUND COLOR FOR THE SIGNAGE ELEMENTS SHALL BE WHITE (OR OFF-WHITE AS SELECTED BY THE LANDSCAPE ARCHITECT FROM SAMPLES PROVIDED BY CONTRACTOR) WITH BLACK CARVED LETTERING AND BLACK OUTLINES AROUND THE SIGN EDGES. THE SIGN EDGES SHALL HAVE A REVEAL SO THAT THE BLACK OUTLINE PROTRUDES FROM THE FACE OF EACH SIGN ELEMENT.

## DISTRICT ENTRY SIGN- ADD ALTERNATE #1 (6.1)







LOADS. CONTRACTOR TO OBTAIN STAMPED STRUCTURAL DRAWING AS PART OF SHOP DRAWING PROCESS FOR ALL ATTACHMENT, INSTALLATION AND FOUNDATION ELEMENTS.

PARKING SIGN- ADD ALTERNATE #1 (6.2)

# PEDESTRIAN SIGN- ADD ALTERNATE #1 (6.3)

LANDSCAPE DETAIL KEYNOTES: DETAIL/SHEET

**PAVEMENT** RE-LAID BRICK PAVERS ON BITUMINOUS BASE 1/ 86 2/86 1.2 BRICK PAVING OVER STRUCTURAL SOIL 1.3 FFFF POROUS PAVE TREE SURROUND 4/ 86 1.4 FLUSH CROSSWALK PAVING 3/ 86 1/ 87 1.5 RAISED CROSSWALK PAVING INTERSECTION PAVING 2/ 87

SITE LIGHTING

SEE ENGINEERS DRAWINGS

PLANTING

LOAM AND SEED 1/ 89 PERENNIAL PLANTING 3.2 2/89 NEW SHRUB PLANTING 3/89 3.4 (+) NEW DECIDUOUS TREE 3.5 ( ) NEW EVERGREEN TREE 5/ 89

SITE FURNISHING

1/ 88 BENCH- 5 TOTAL 2/88 5.2 TRASH RECEPTACLE- 4 TOTAL FLAGPOLE- 1 TOTAL 5.3 3/ 88 5.5 BIKE RACK- 3 TOTAL 4/ 88

SIGNAGE- ADD ALTERNATE #1

DISTRICT ENTRY SIGN- ADD ALTERNATE #1- 2 TOTAL 1/90 6.2 PARKING SIGN- ADD ALTERNATE #1- 2 TOTAL 2/ 90 PEDESTRIAN SIGN- ADD ALTERNATE #1- 5 TOTAL 3/ 90

#### **ADD ALTERNATE 1-WAYFINDING SIGNAGE NOTES:**

AN ADD ALTERNATE PRICE SHALL BE PROVIDED FOR THE DESIGN AND CONSTRUCTION OF A SIGNAGE SYSTEM AS INDICATED IN THE DRAWINGS. LOCATIONS FOR THE SIGNS AND GENERAL DESIGN INTENT IS INDICATED. CONTRACTOR IS RESPONSIBLE FOR DESIGNING THE FULL DETAILS OF THE SIGNAGE SYSTEM, INCLUDING BUT NOT LIMITED TO FOUNDATIONS, STRUCTURAL SUPPORTS, AND ALL SIGNAGE ELEMENTS. CONTRACTOR SHALL SUBMIT SHOW DRAWINGS SHOWING ALL ELEMENTS OF THE SIGNAGE DESIGN TO THE LANDSCAPE ARCHITECT AND OWNER'S REPRESENTATIVE FOR APPROVAL. OWNER'S REPRESENTATIVE AND LANDSCAPE ARCHITECT RESERVE THE RIGHT TO MAKE CHANGES TO THE SHOP DRAWINGS TO REFLECT THE DESIRED HISTORIC DESIGN INTENT. EXACT CONTENT OF EACH SIGN WILL BE PROVIDED BY THE TOWN DURING THE SHOP DRAWING PROCESS.

GENERAL DETAILS INDICATING BASIC INTENT FOR THE PROPOSED SIGNS ARE INCLUDED IN THE DRAWING SET.

MINIMUM OF 3" HEIGHT.

6" HEIGHT.

THE FOLLOWING SHALL BE ASSUMED AND INCLUDED IN THE SIGNAGE ELEMENTS:

- 1. ALL TEXT ON PEDESTRIAN WAYFINDING SIGNS SHALL BE A
- 2. ALL TEXT ON THE VEHICULAR WAYFINDING SIGNS (REGIONAL DISTRICT SIGNS AND PARKING SIGNS) SHALL BE A MINIMUM
- 3. MATERIALS FOR THE SIGNS SHALL BE CARVED HIGH DENSITY URETHANE FOAM (HDU), OFF-WHITE BACKGROUND (FINISH OF ALL POSTS AND SIGNS TO MATCH) WITH BLACK LETTERS. EXACT SHADES OF WHITE AND BLACK SHALL BE DETERMINED FROM COLOR SAMPLES. POST SHALL BE PRESSURE TREATED WOOD (WITHOUT BLEMISHES, KNOTS, OR ROUGH SURFACES), PRIMED AND PAINTED WHITE.
- 4. ALL STRUCTURAL ENGINEERING OF THE SIGNS, FOUNDATIONS, ATTACHMENTS, AND INSTALLATION DETAILS IS THE RESPONSIBILITY OF THE CONTRACTOR.
- 5. ALL POSTS SHALL BE DIRECT BURIED INTO THE GROUND, AT NECESSARY DEPTHS AND INSTALLATION DETAILS AS DETERMINED BY THE SIGN MANUFACTURER AND STRUCTURAL ENGINEER.
- 6. CONTRACTOR SHALL PROVIDE A TEN YEAR WARRANTY ON BOTH THE INSTALLATION AND MATERIALS OF ALL SIGNAGE ELEMENTS.



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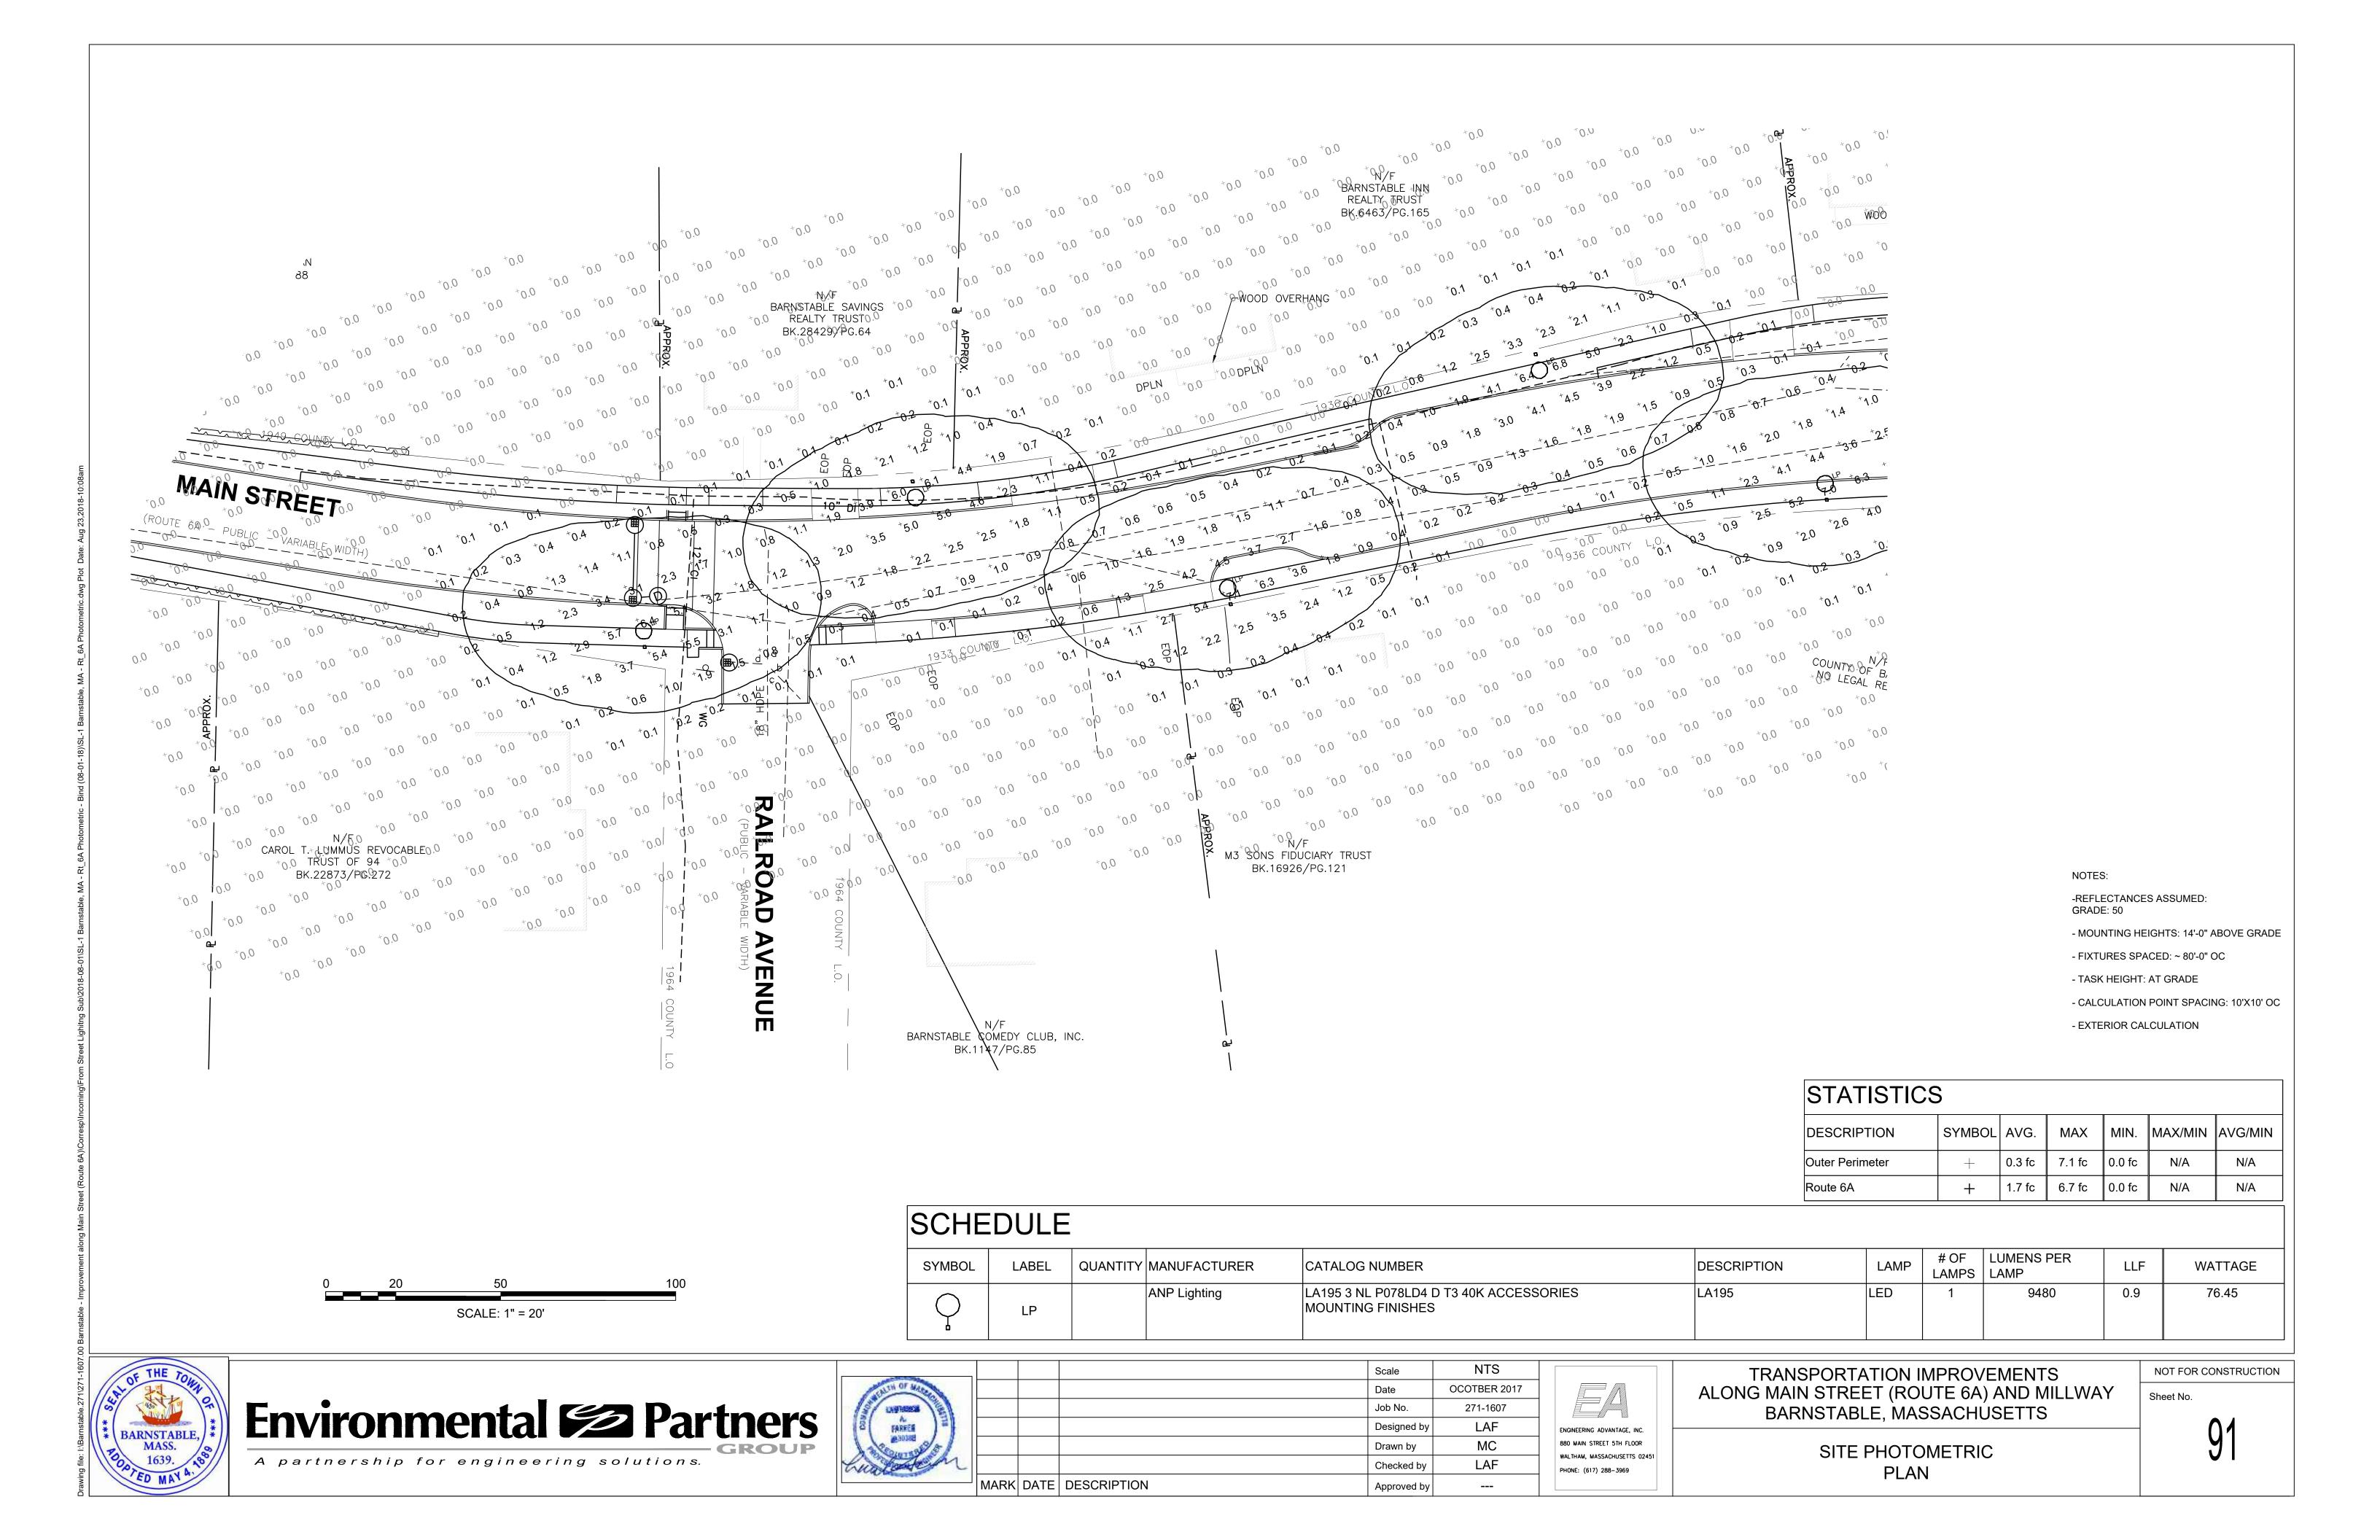
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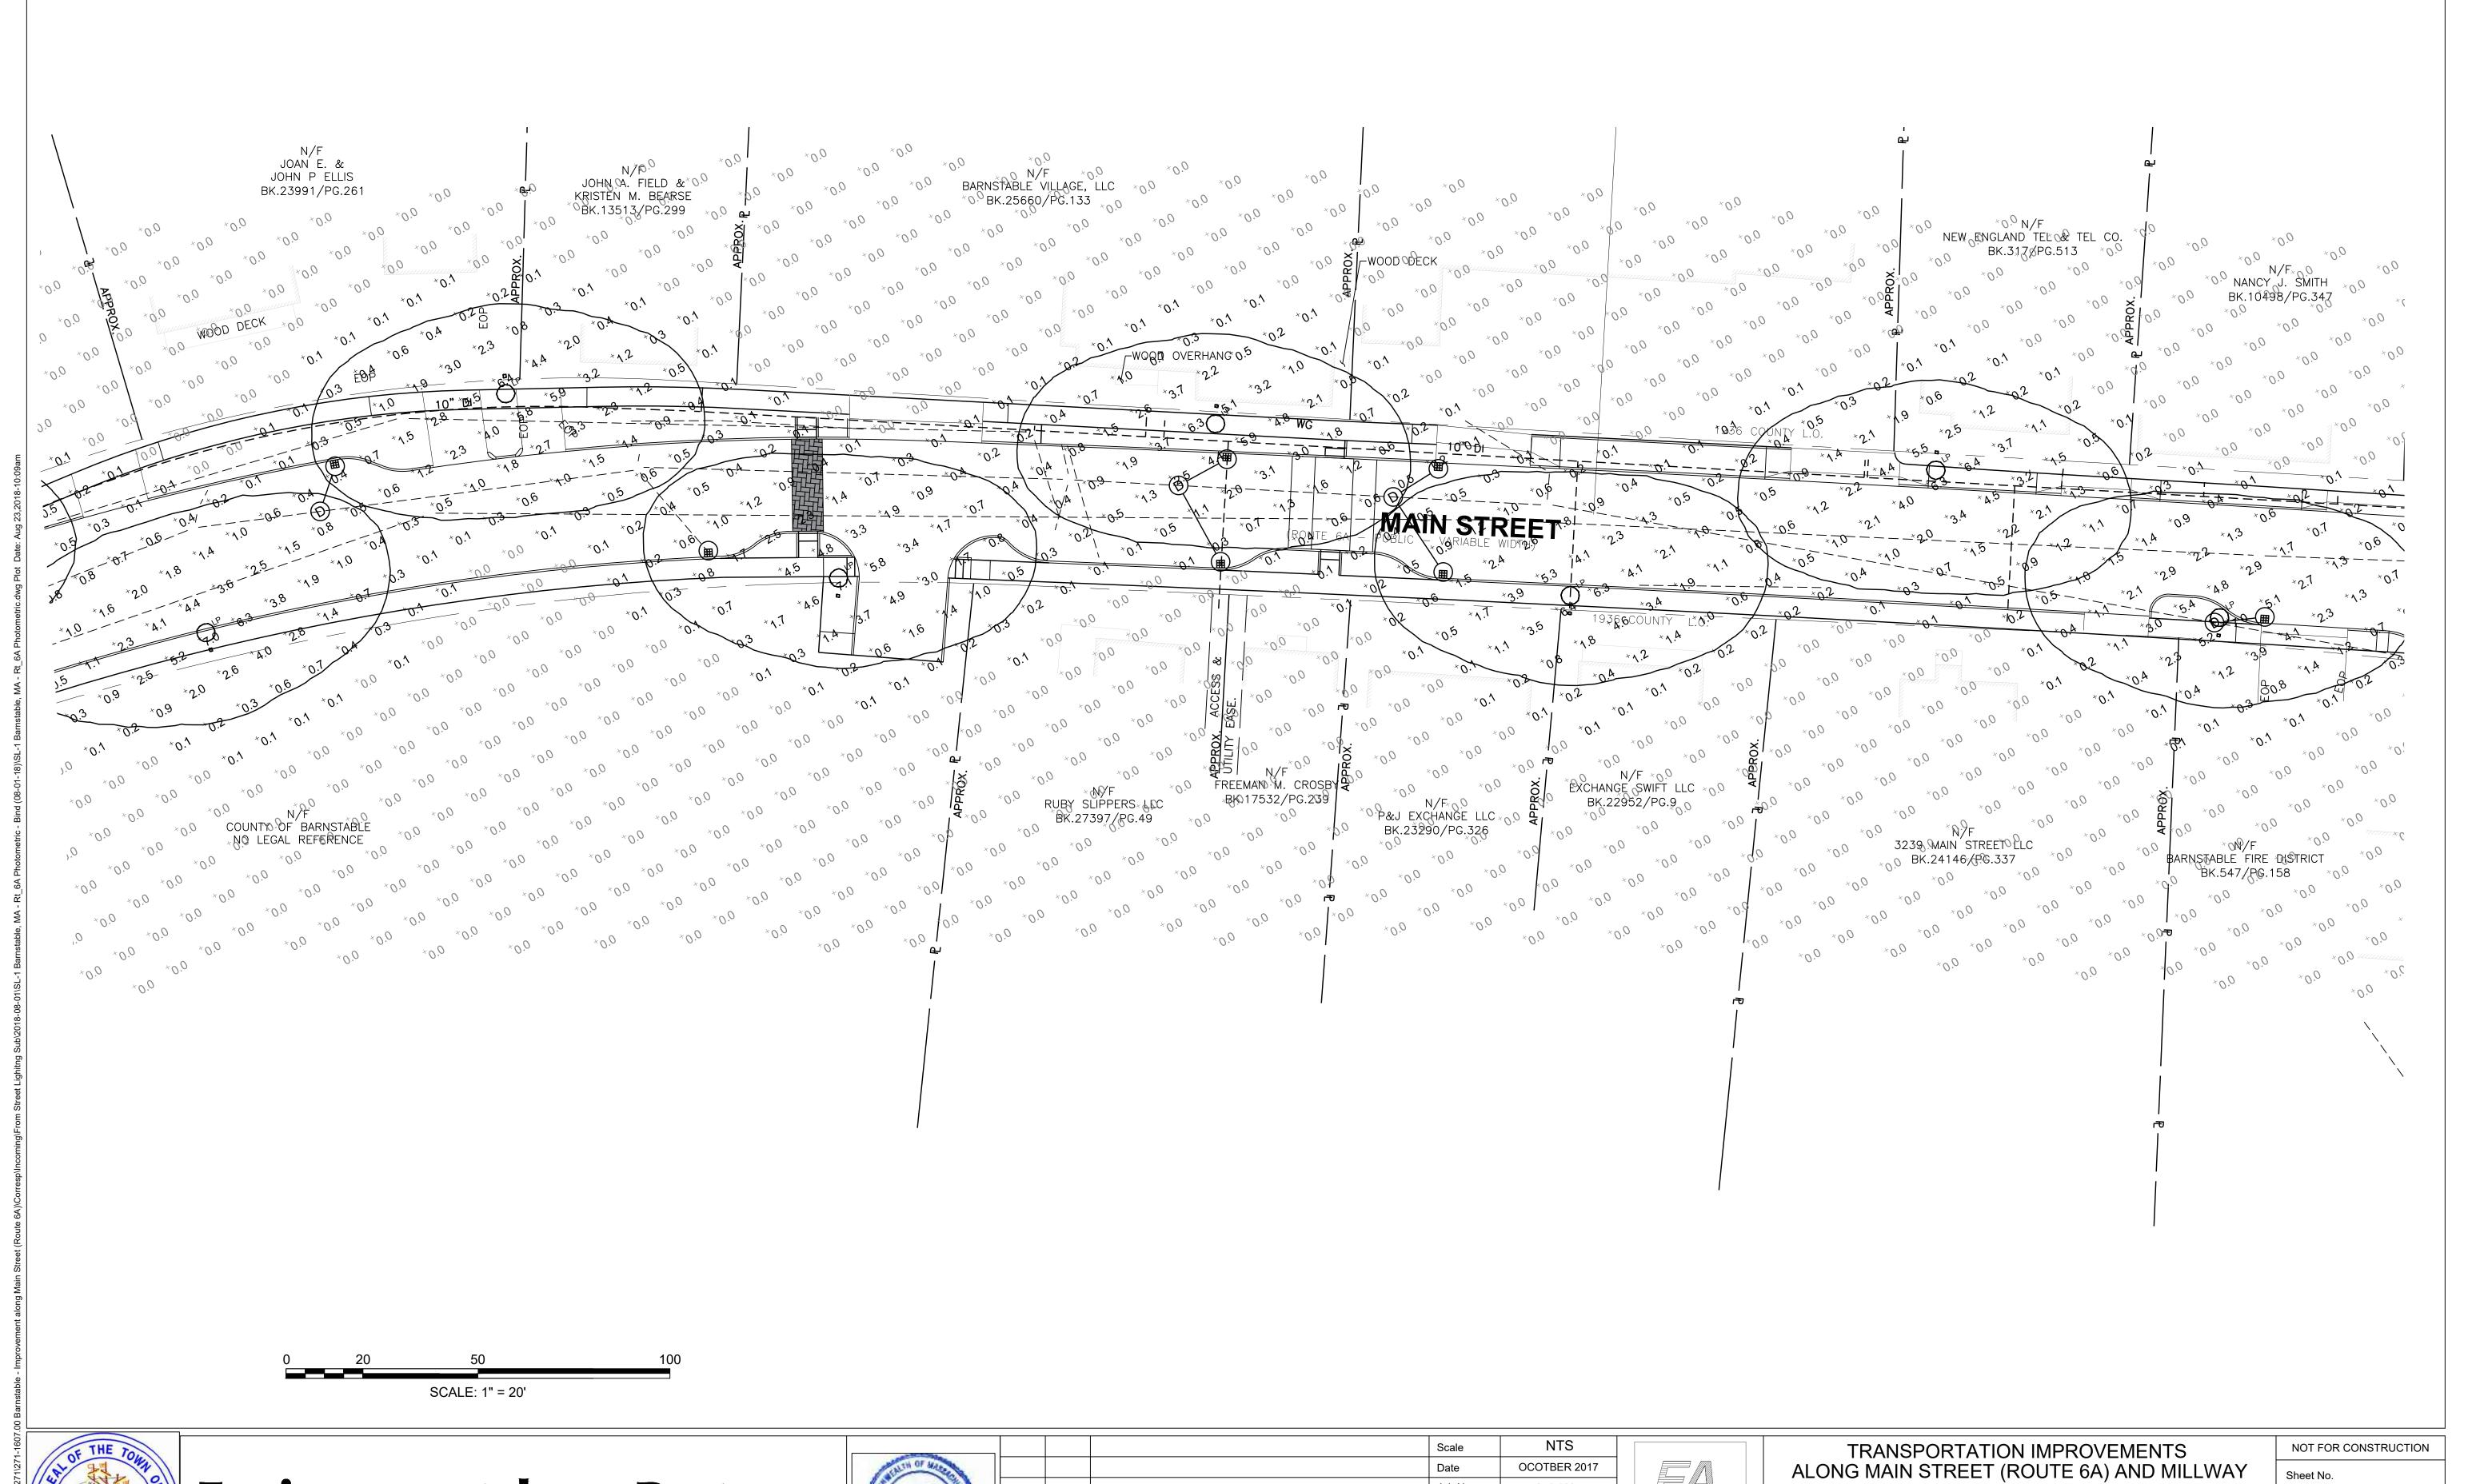
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TRANSPORTATION IMPROVEMENTS ALONG ROUTE 6A AND MILLWAY BARNSTABLE, MASSACHUSETTS

> LANDSCAPE DETAILS: SIGNAGE-05

CONSTRUCTION DOCUMENTS



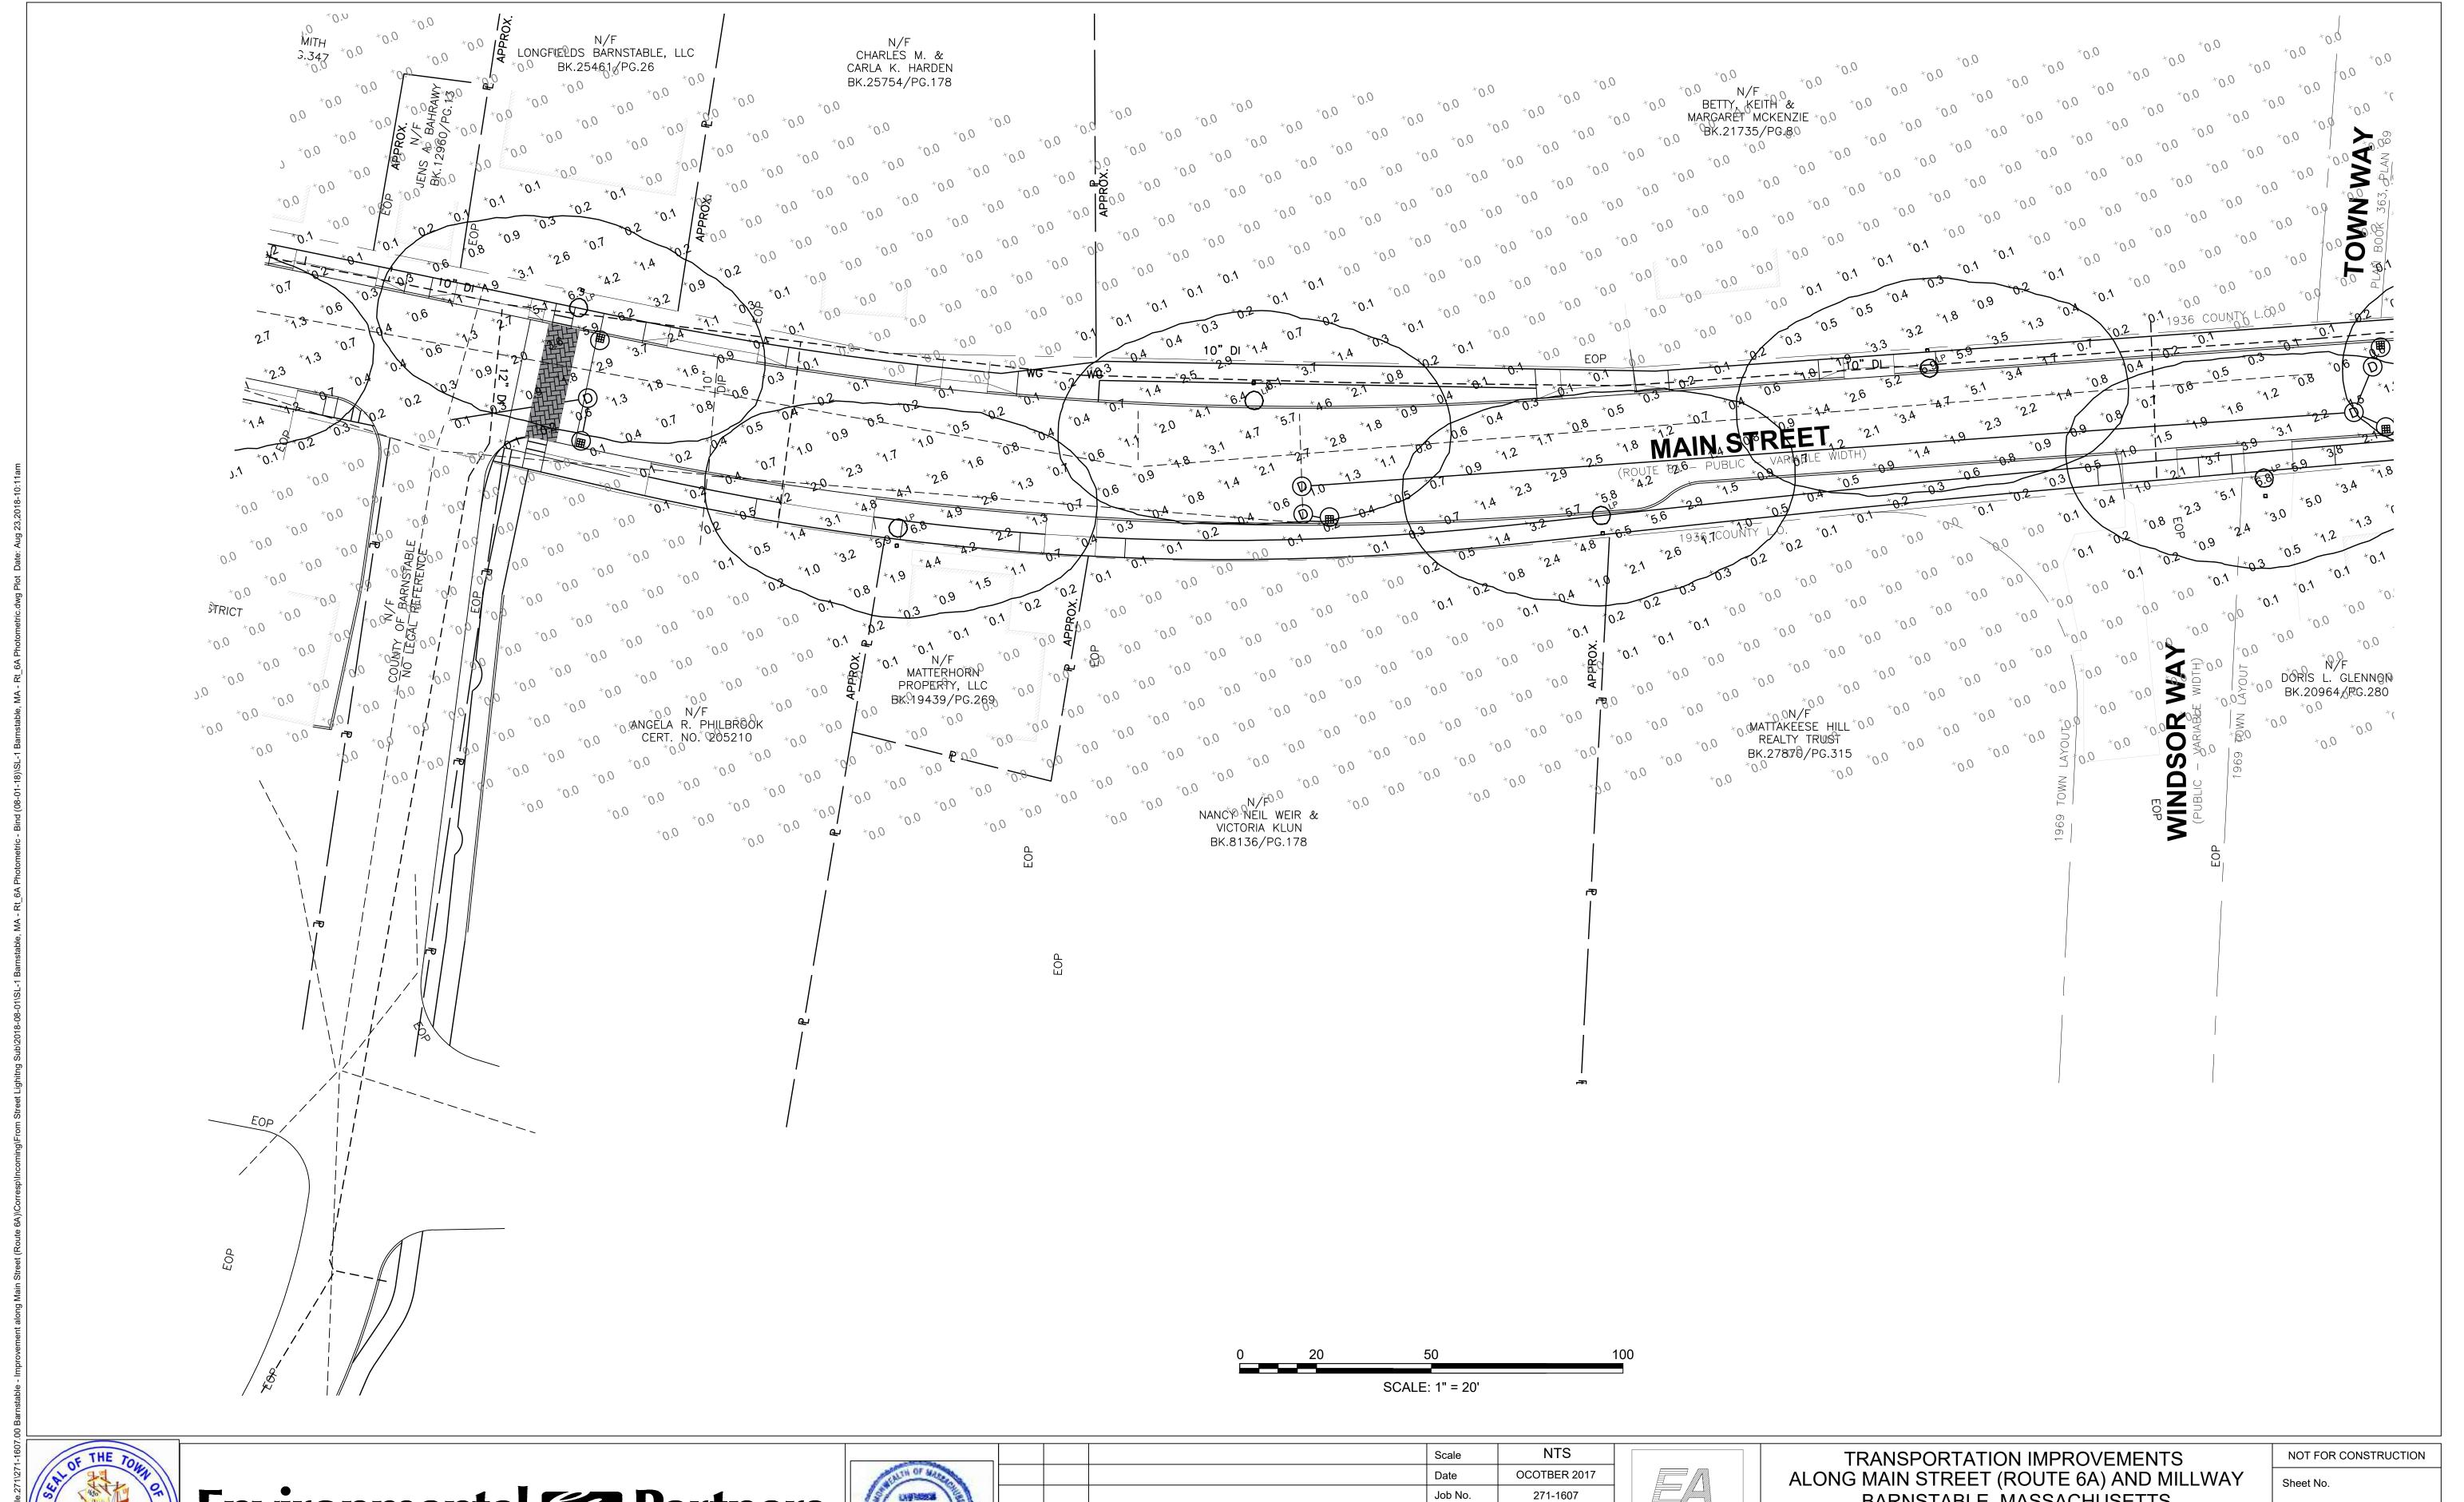




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ALONG MAIN STREET (ROUTE 6A) AND MILLWAY BARNSTABLE, MASSACHÚSETTS

> SITE PHOTOMETRIC PLAN

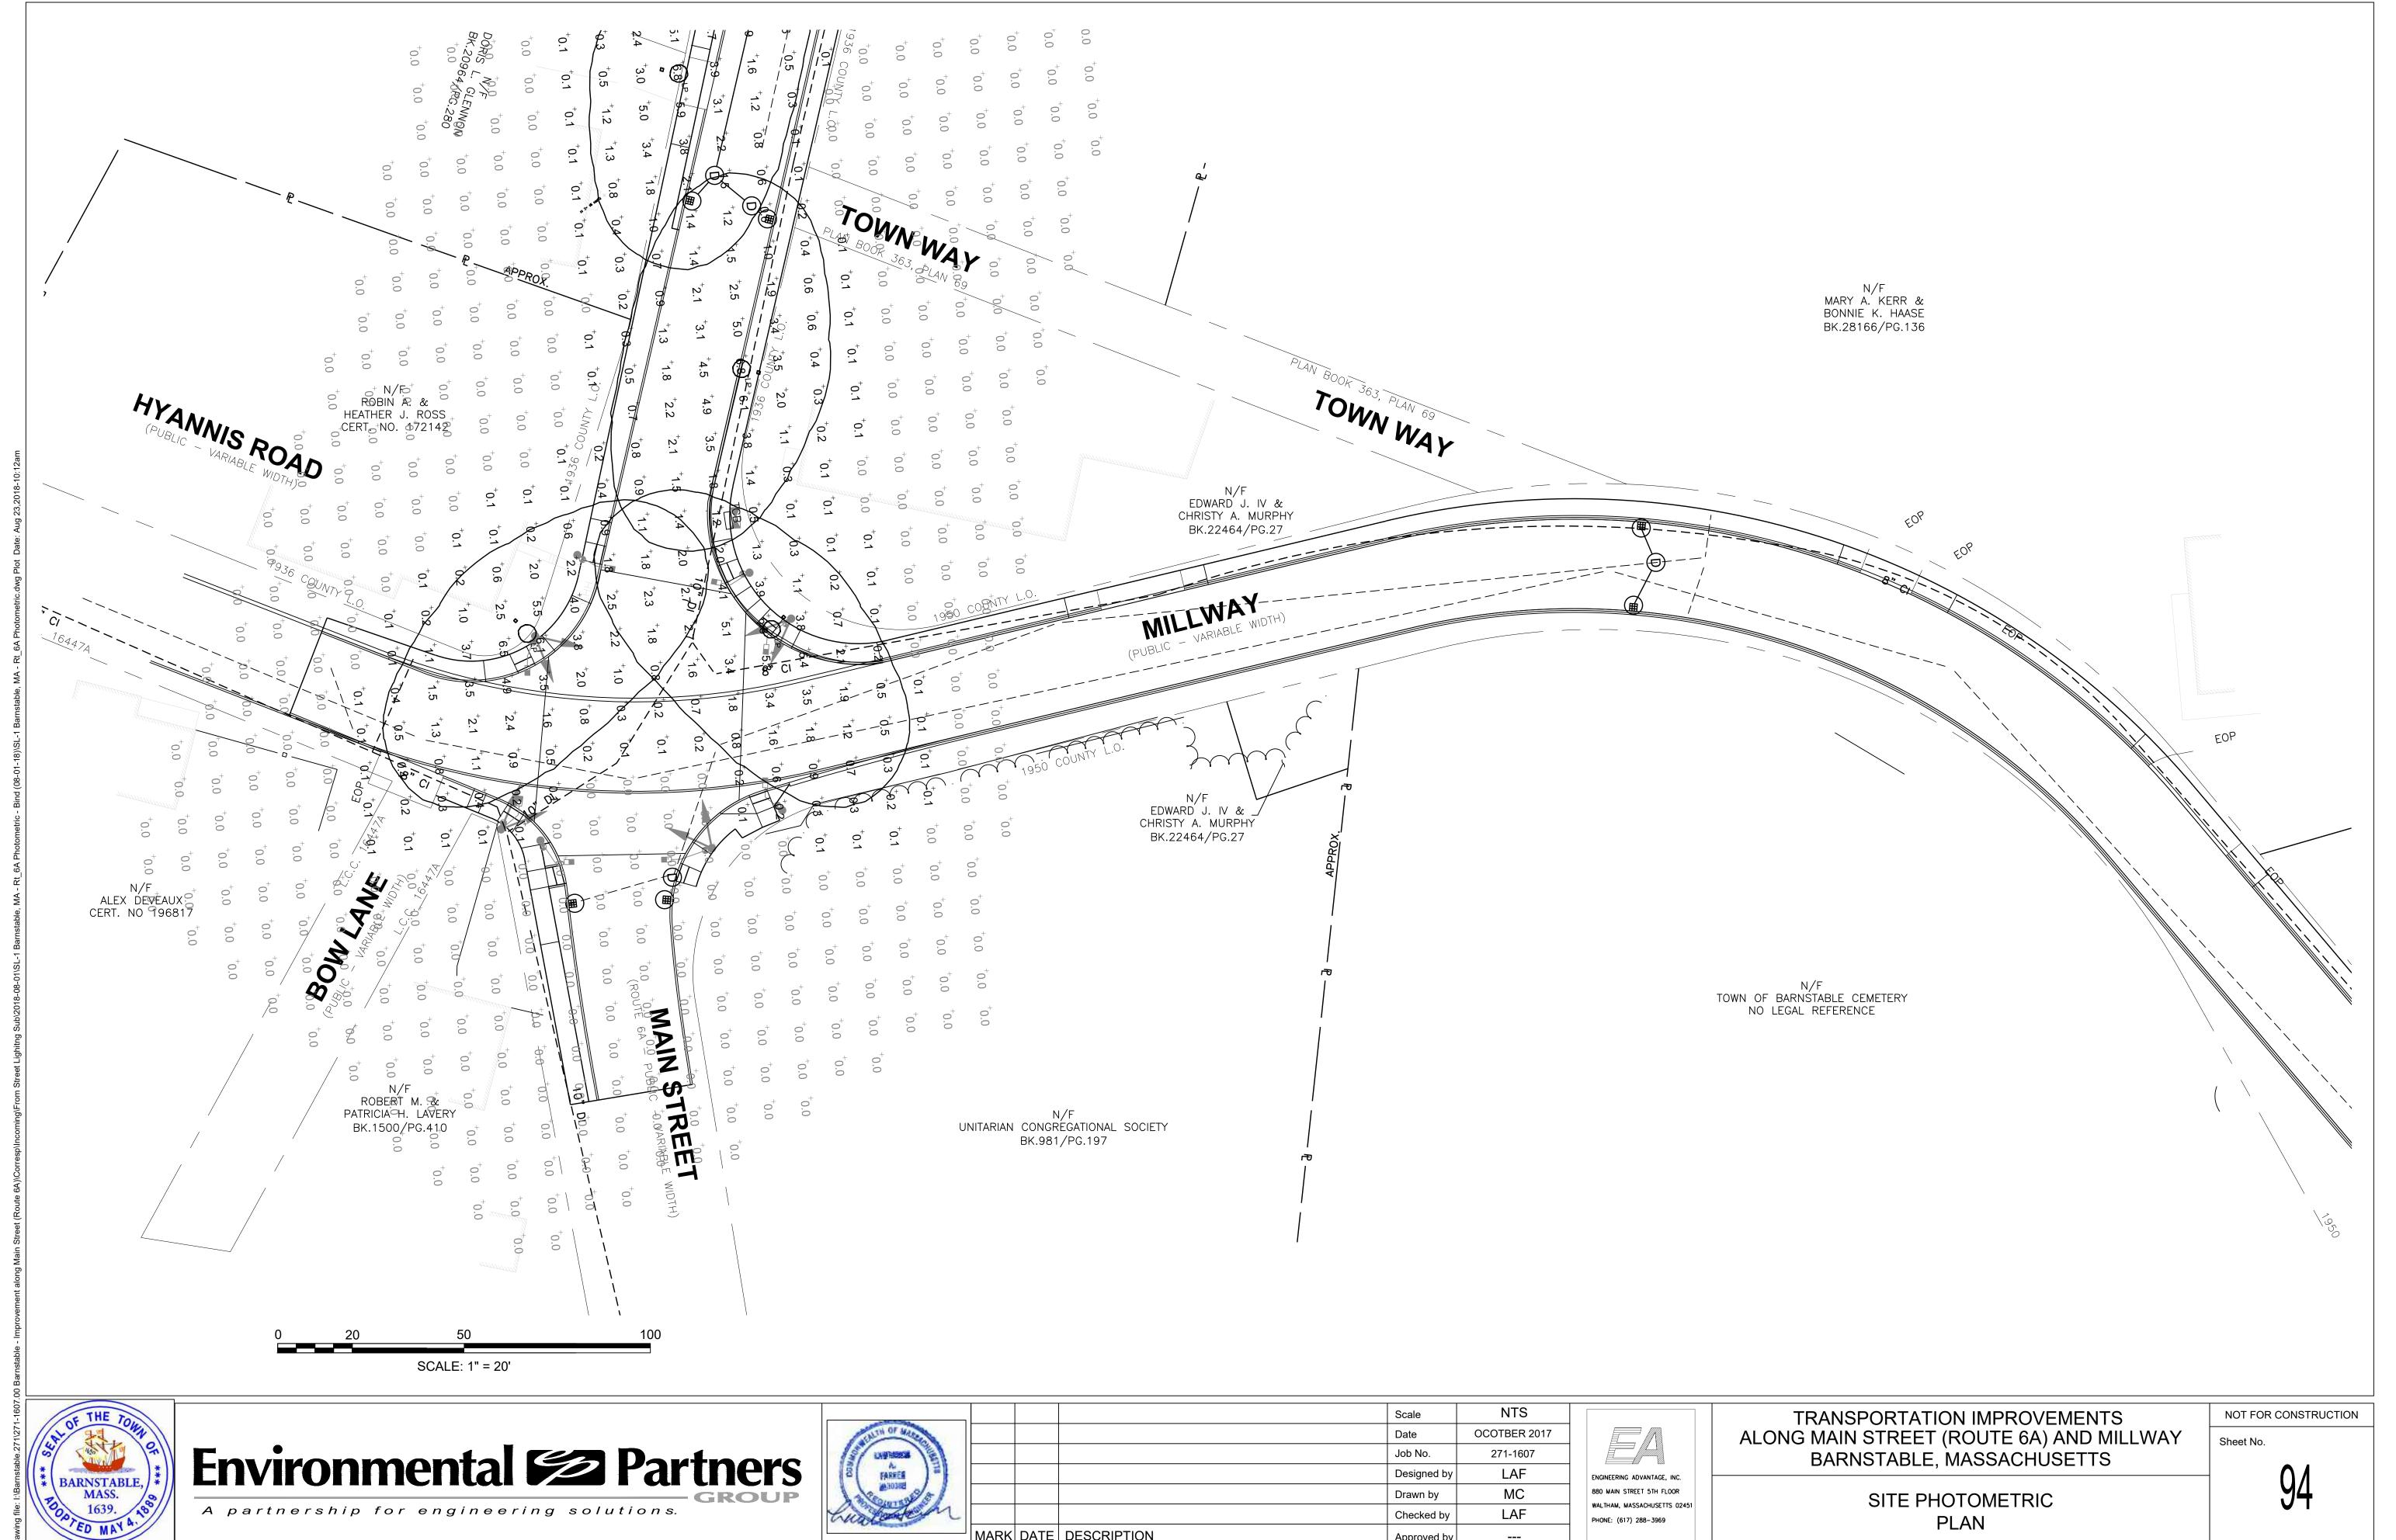




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BARNSTABLE, MASSACHUSETTS

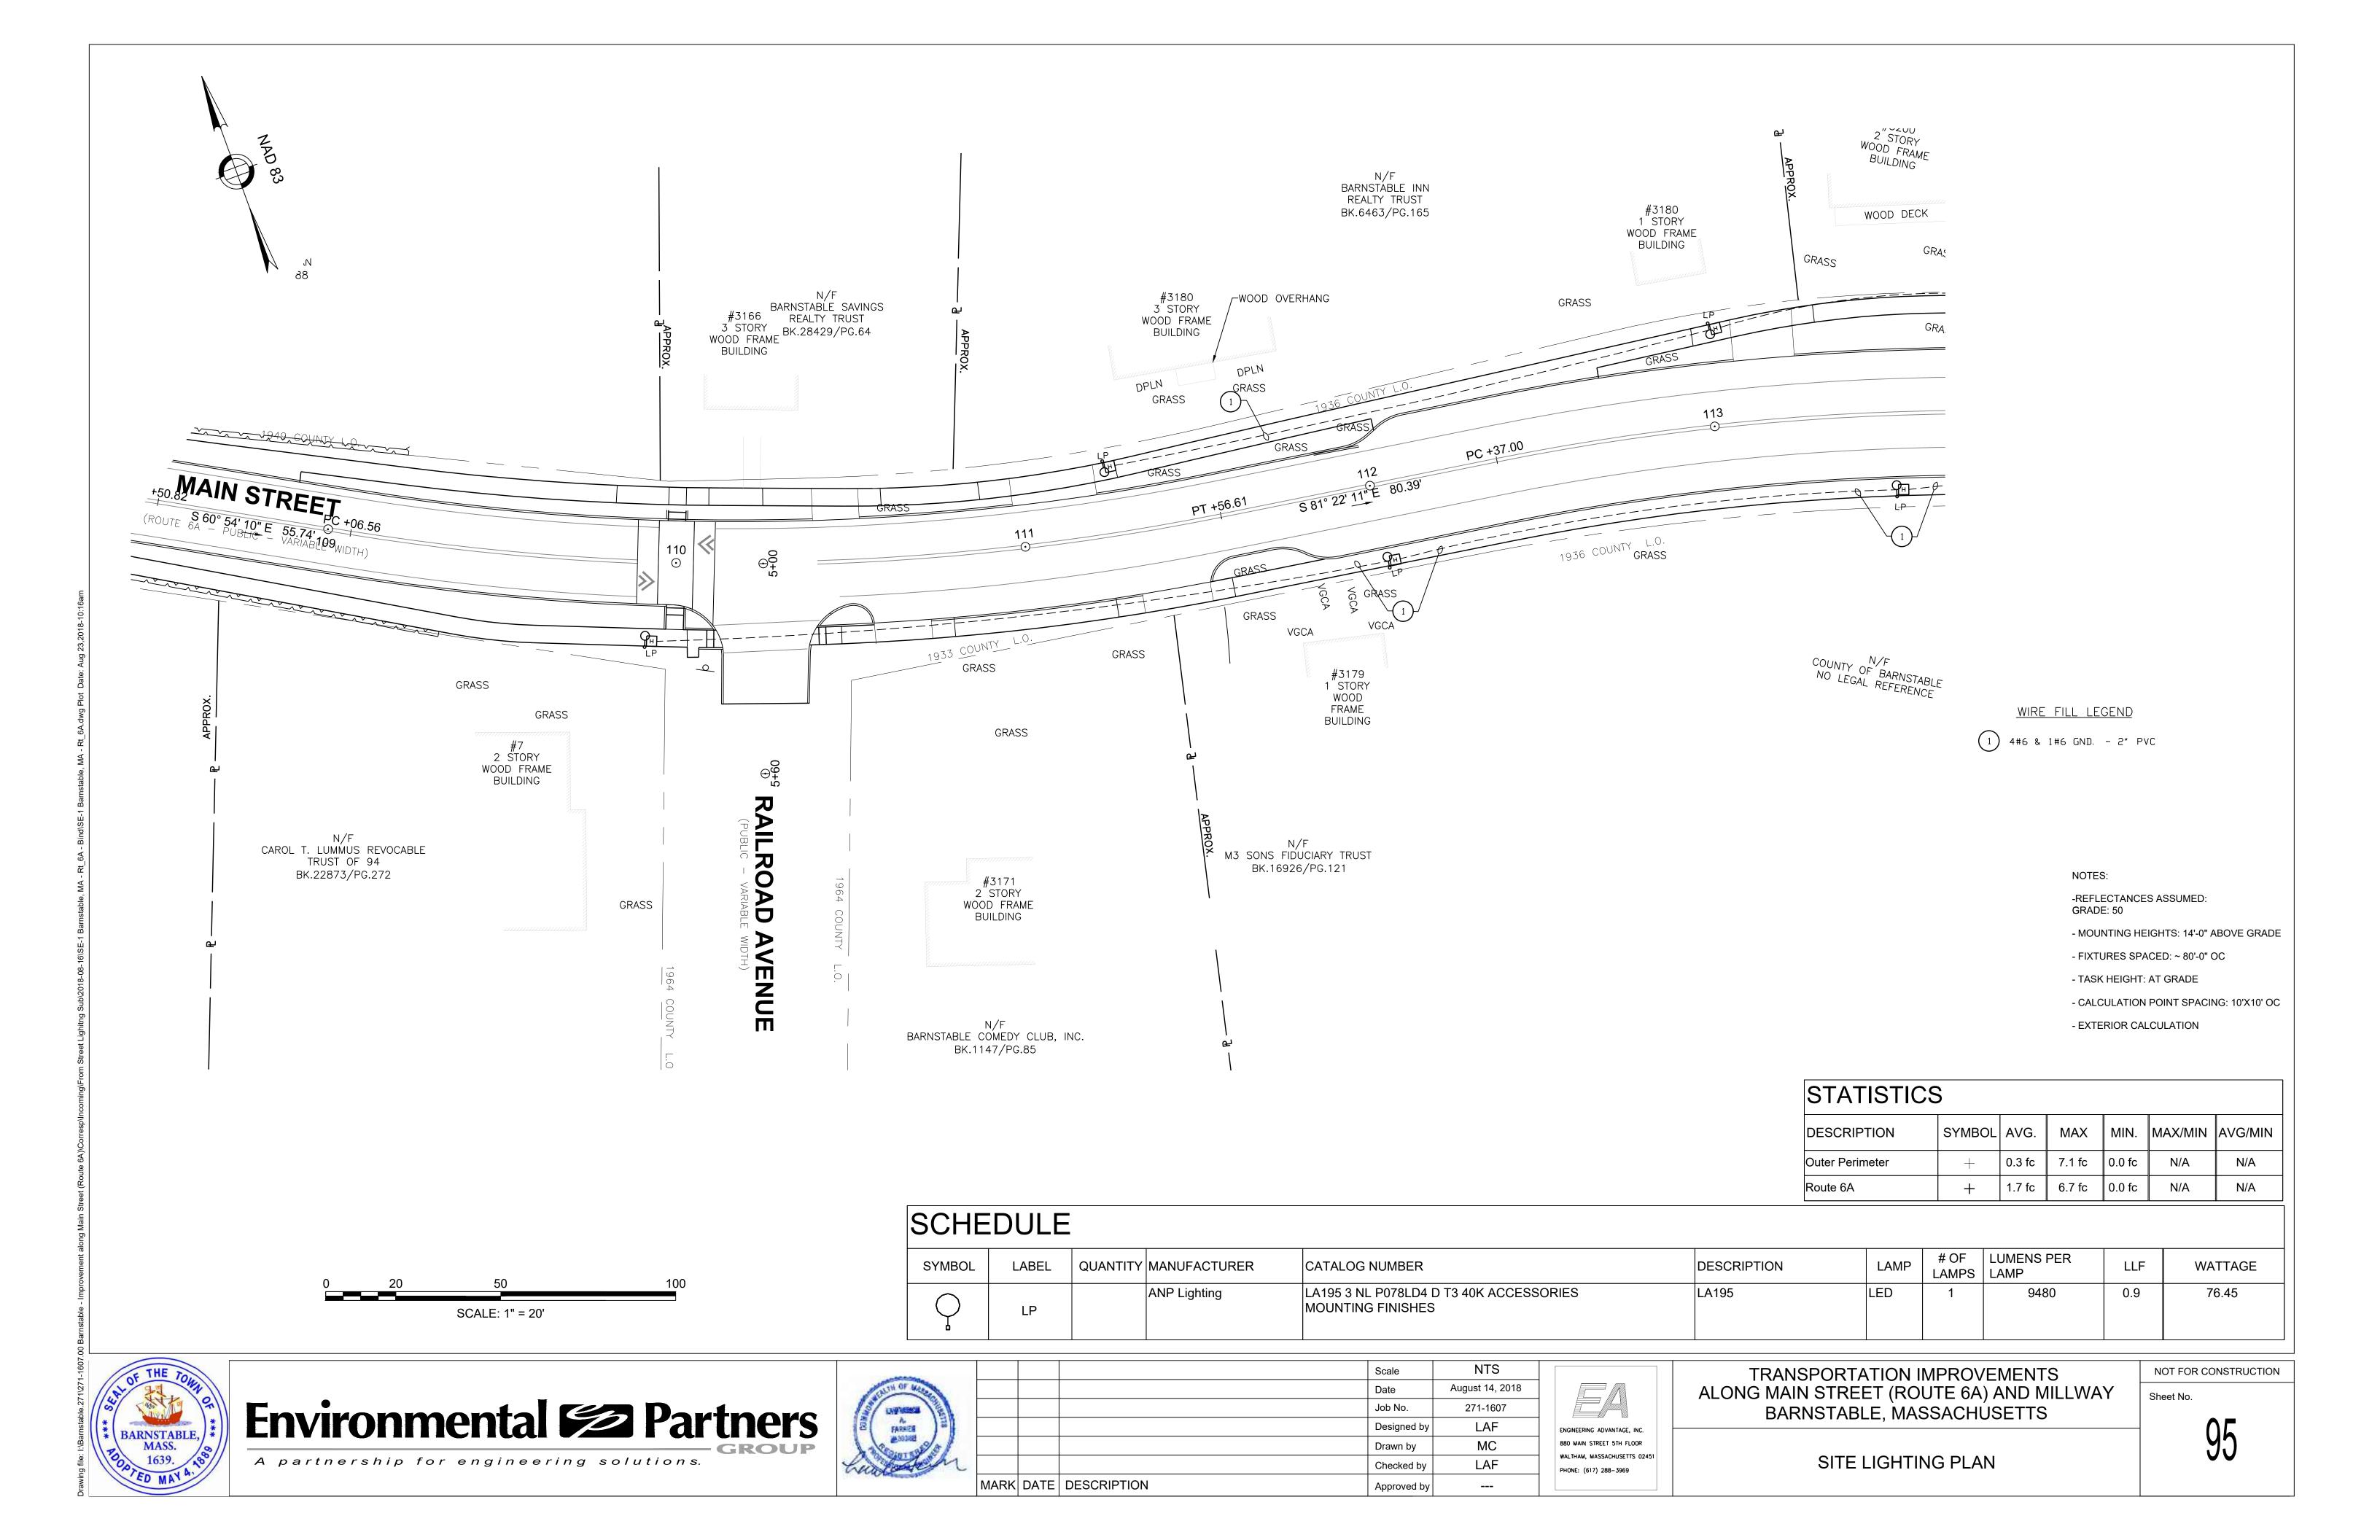
SITE PHOTOMETRIC PLAN

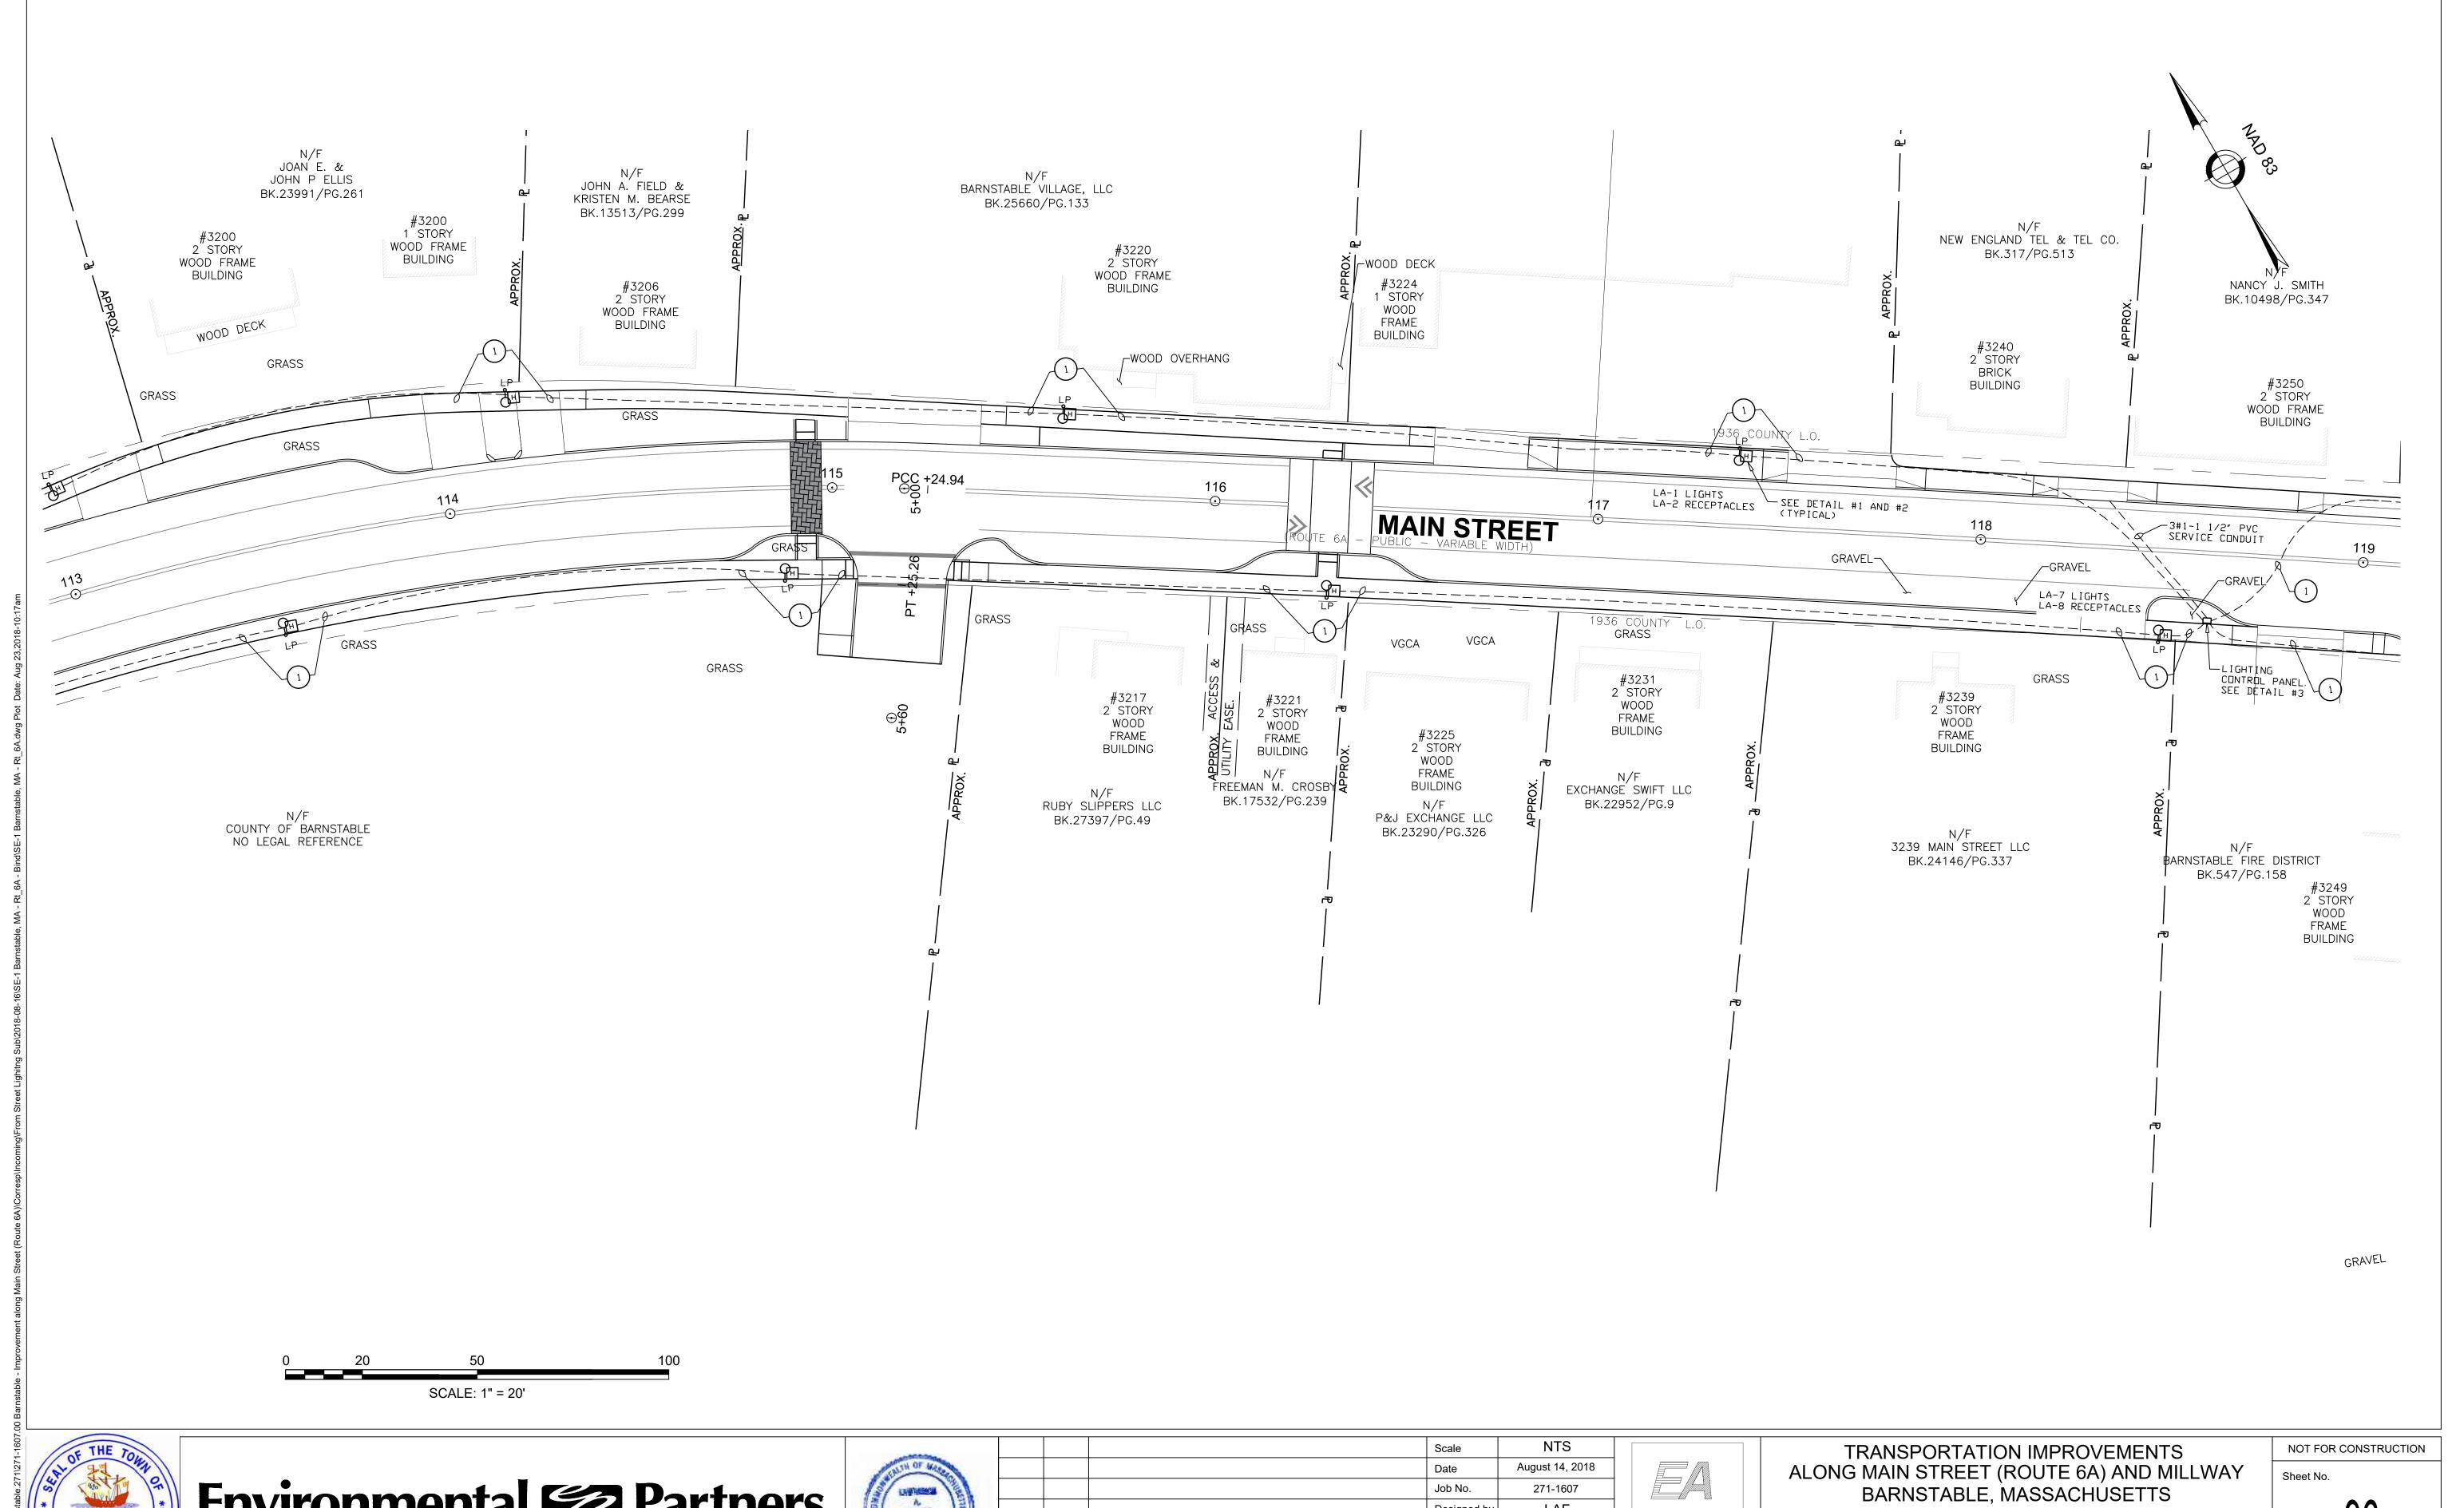




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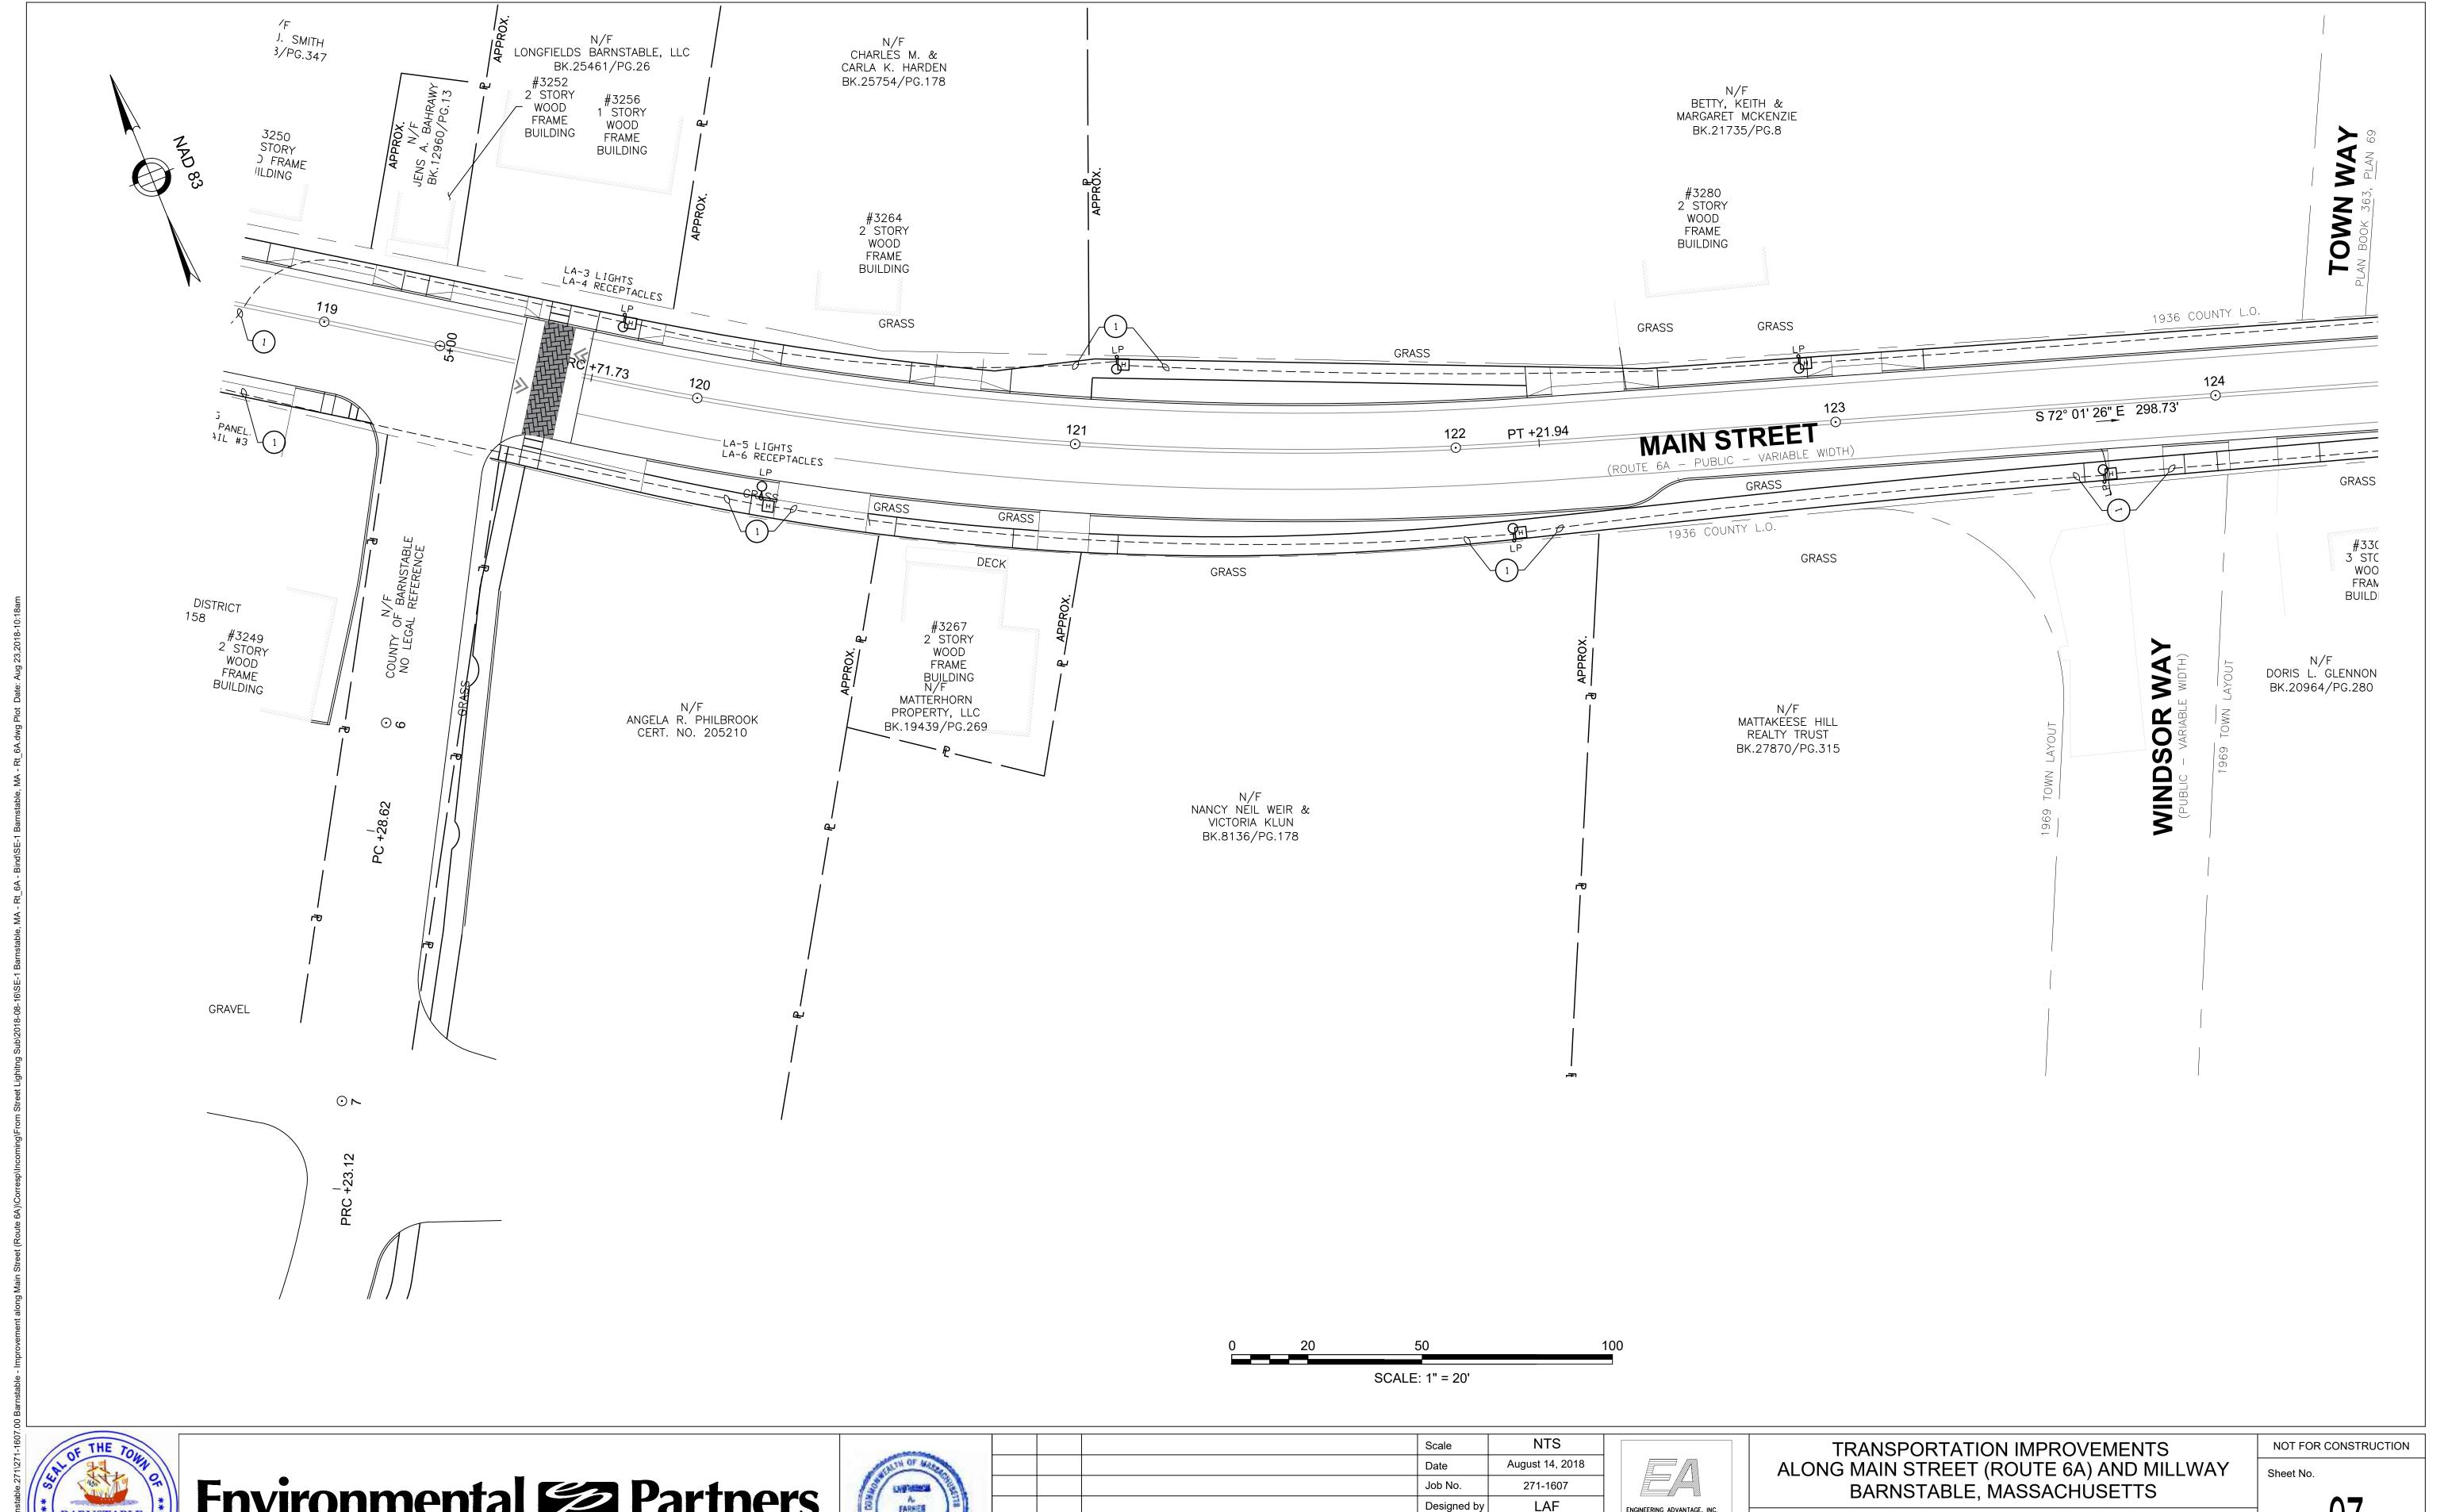


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SITE LIGHTING PLAN

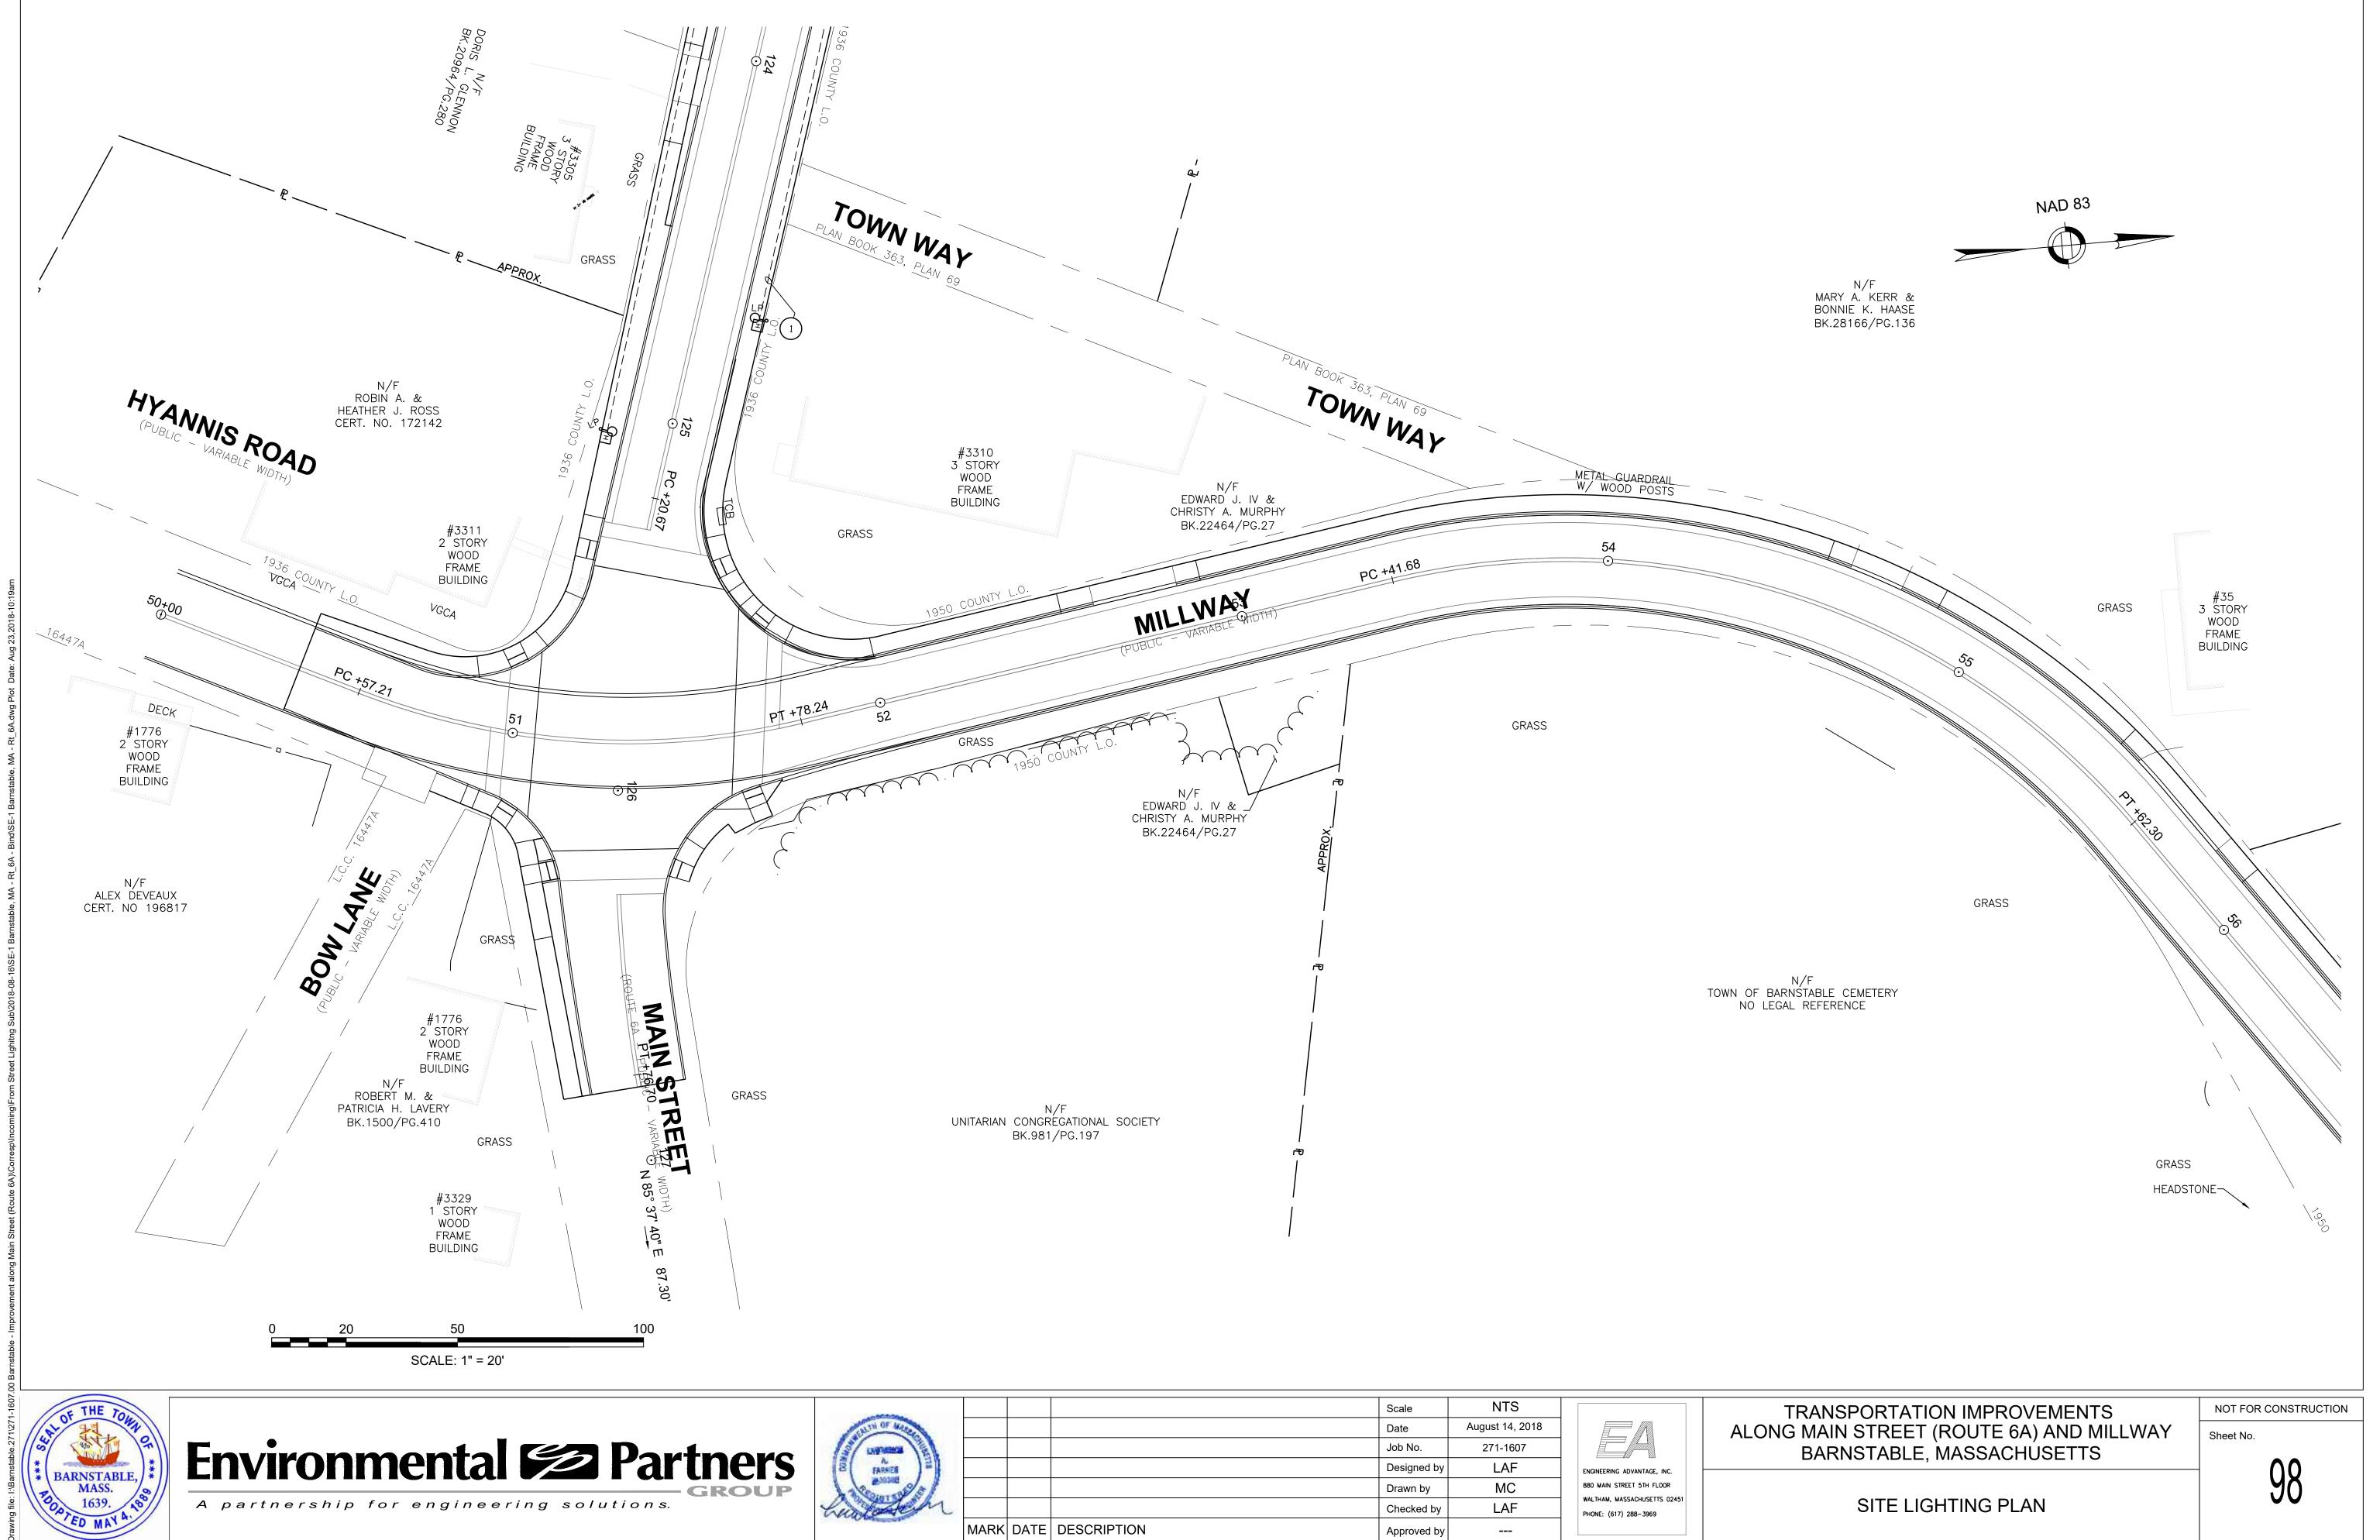


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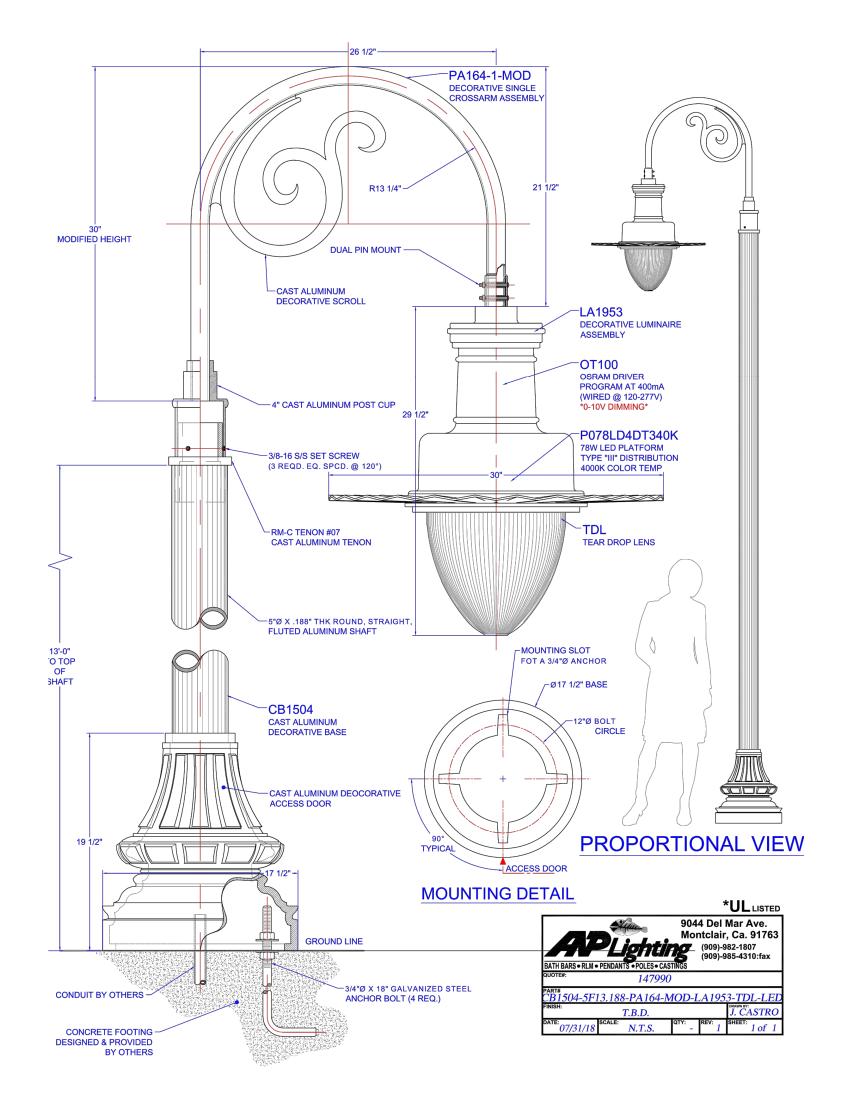


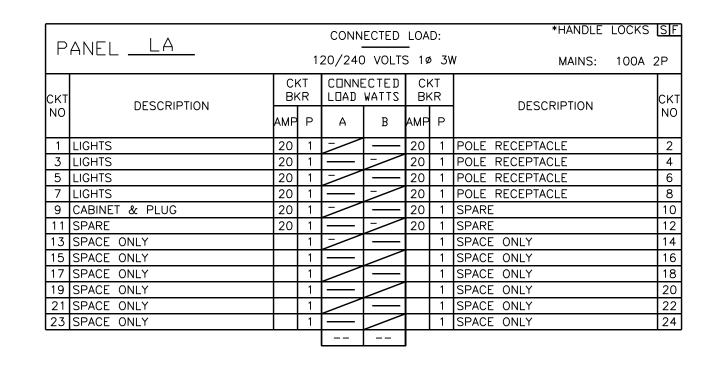


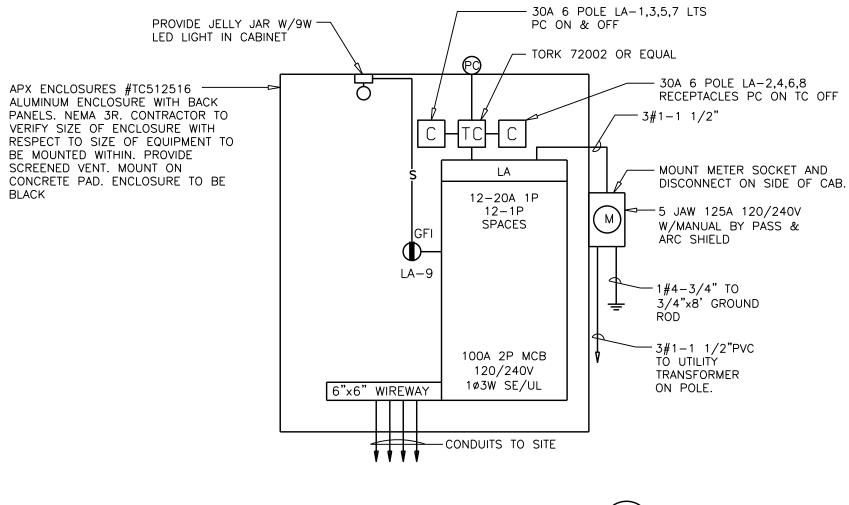
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ENGINEERING ADVANTAGE, INC.

SITE LIGHTING PLAN

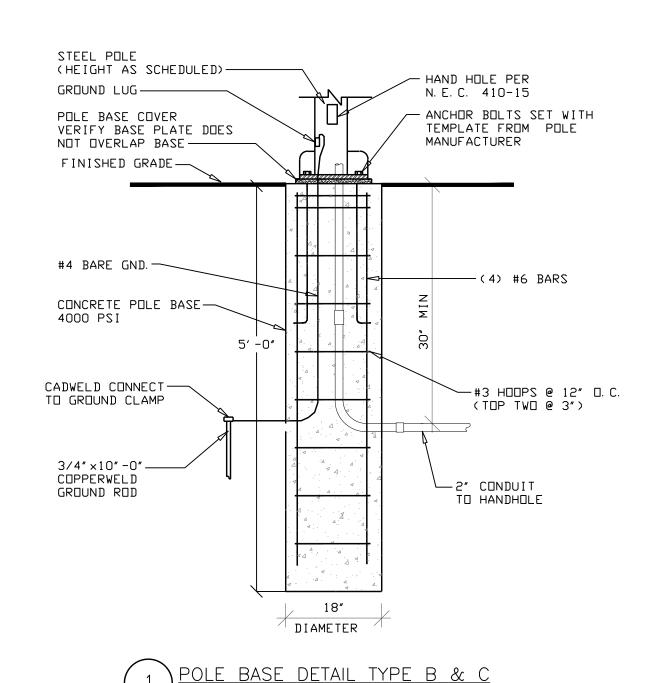


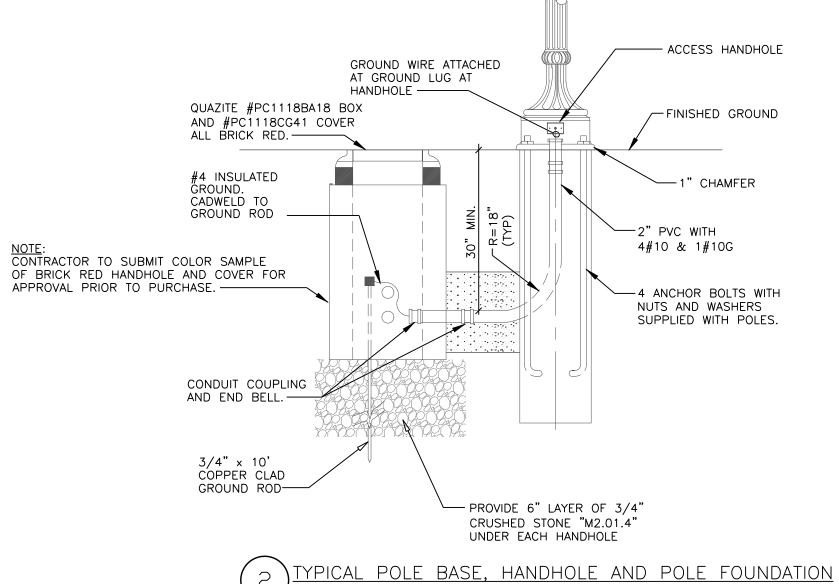


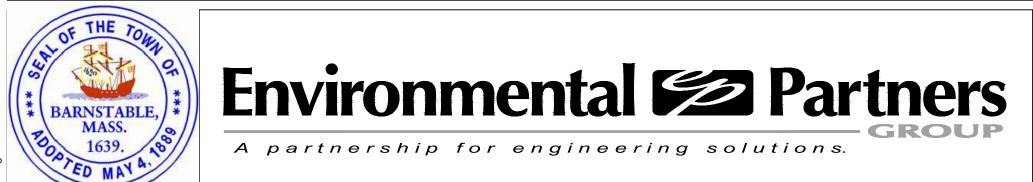


LIGHTING CONTROL PANEL "LA"

NOT TO SCALE









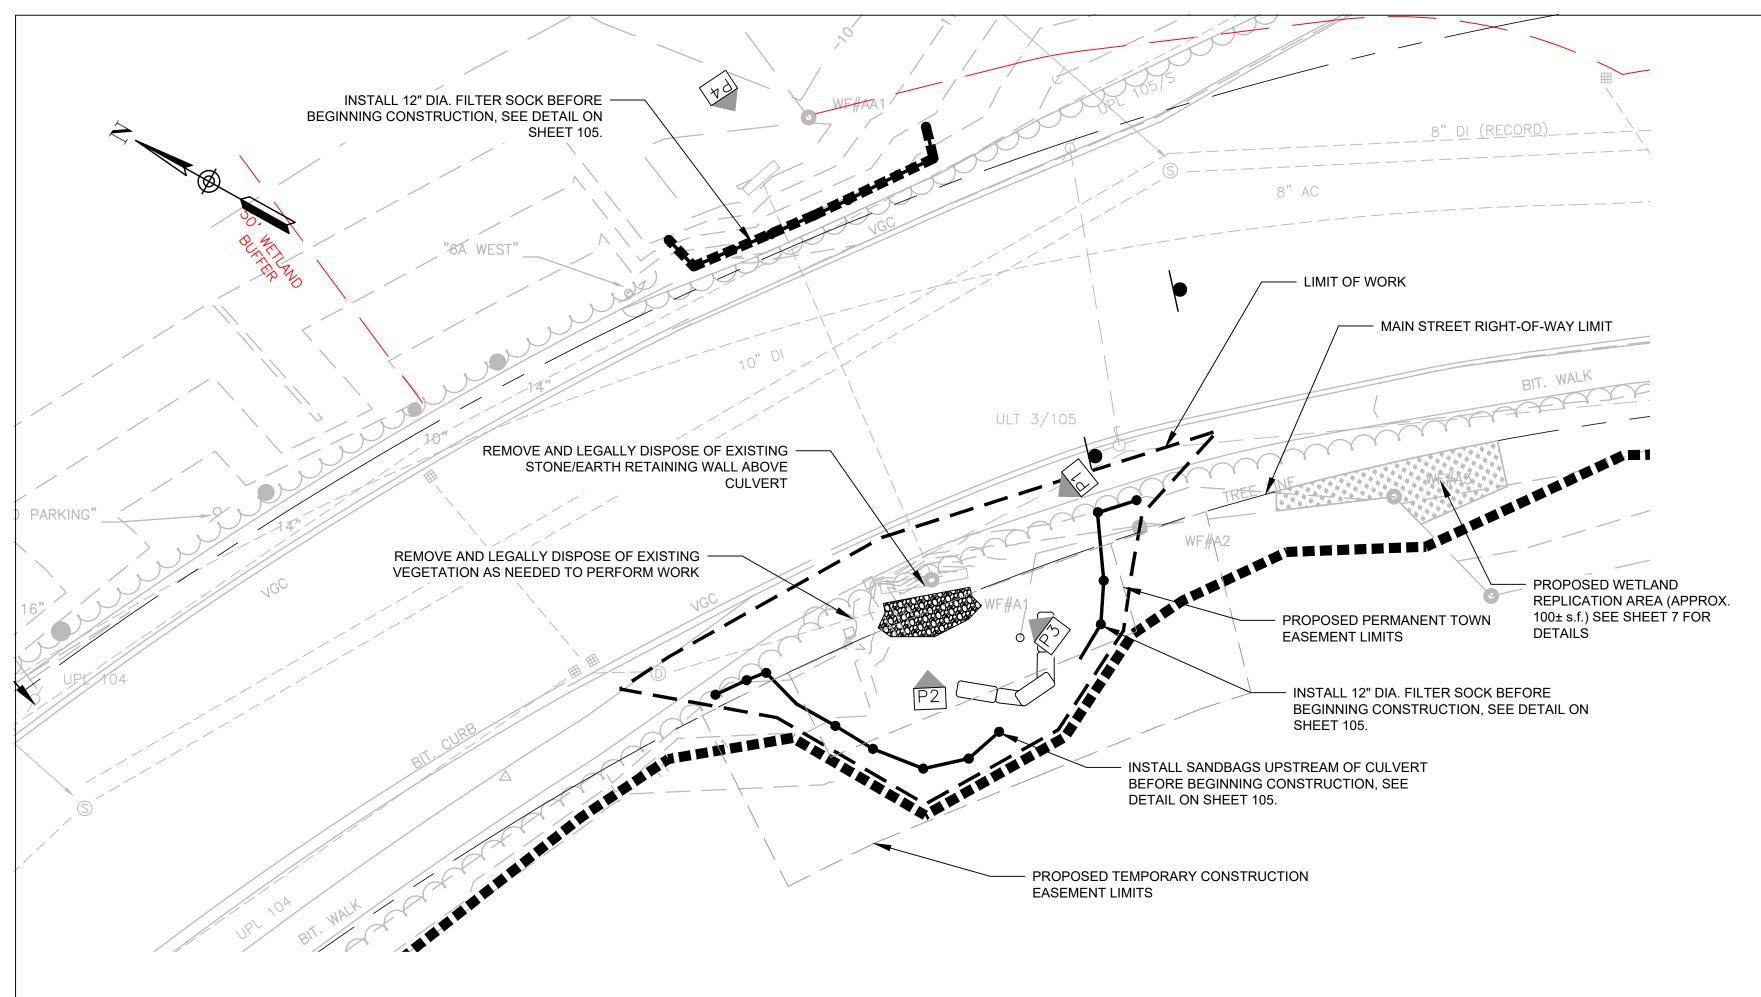
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TRANSPORTATION IMPROVEMENTS ALONG MAIN STREET (ROUTE 6A) AND MILLWAY BARNSTABLE, MASSACHUSETTS

NOT TO SCALE

SITE ELECTRICAL DETAIL PLAN NOT FOR CONSTRUCTION
Sheet No.





# GENERAL CONSTRUCTION PROCEDURE

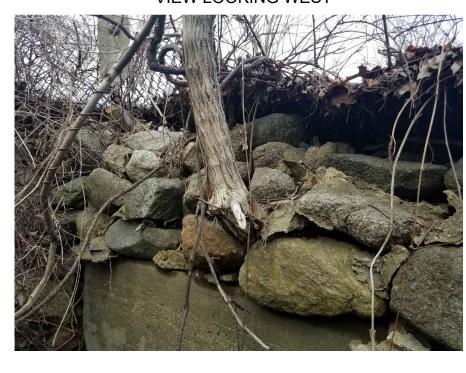
- THE CONTRACTOR SHALL PROVIDE AND INSTALL PROJECT SIGNS AND TRAFFIC DETOUR SIGNS AS REQUIRED TO COMPLETE THE WORK.
- 2. THE CONTRACTOR SHALL INSTALL EROSION CONTROLS PRIOR TO ANY CLEARING ACTIVITIES. EROSION CONTROLS SHALL BE INSPECTED AND APPROVED BY THE CONSERVATION AGENT BEFORE ANY FURTHER ACTIVITIES COMMENCE.
- THE CONTRACTOR SHALL DESIGNATE AN AREA FOR STORAGE OF MATERIAL, EQUIPMENT, TEMPORARY FACILITIES AS APPROVED BY THE ENGINEER AND THE TOWN OF BARNSTABLE.
- 4. START ANY NECESSARY DEWATERING BEFORE ANY EXCAVATION ACTIVITIES TAKE PLACE.
- 5. EXCAVATE AND REMOVE EXISTING STONE/EARTH RETAINING WALL ABOVE CULVERT AND ANY ASSOCIATED VEGITATION, RIPRAP OR MATERIALS NEEDED TO PERFORM THE WORK.
- 6. EXCAVATE TO BOTTOM OF EXISTING HEADWALL & SUBGRADE.
- 7. INSTALL FILTER FABRIC AND COMPACTED CRUSHED STONE AS SPECIFIED AND SHOWN ON THE DRAWINGS.
- 8. PLACE CAST-IN-PLACE REINFORCED CONCRETE RETAINING WALL AND CAST-IN-PLACE REINFORCED CONCRETE FOUNDATION AS SHOWN ON THE DRAWINGS.
- 9. PLACE CAST-IN-PLACE REINFORCED CONCRETE HEADWALL AS SHOWN ON THE DRAWINGS. DOWEL AND EPOXY #5 REBAR @ 6" O.C. (1-FT DEPTH) AT MIN. 6" EMBED. DEPTH AROUND ALL SIDES OF BOX CULVERT INTO EXISTING PRECAST CONCRETE HEADWALL.

# GENERAL CONSTRUCTION PROCEDURE (CONT.)

- 10. PERFORM BANK STABILIZATION AND RESTORATION WORK
- 11. REMOVE TEMPORARY SANDBAG DAM SYSTEM AND BYPASS PIPING.
- 12. INSTALL GUARD RAIL AS SHOWN.
- 13. PERFORM FINAL CLEANUP.



CULVERT, VIEW LOOKING WEST



EXISTING UPSTREAM CULVERT, VIEW LOOKING NORTH

PHOTO 3



PHOTO 4

VIEW LOOKING SOUTH

EXISTING DOWNSTREAM CULVERT,

PHOTO 2 STONE/EARTH RETAINING WALL ABOVE **UPSTREAM CULVERT** VIEW LOOKING NORTH

# DEWATERING & BY-PASS PIPING GENERAL PROCEDURE (CONT.):

- 9. INSTALL EXCAVATION SUPPORT AS NECESSARY.
- 10. MAKE FINAL ELEVATION AND DIRECTION ADJUSTMENTS
- 11. INSTALL POLYETHYLENE SHEETING ALONG THE OUTSIDE FACE OF THE SANDBAGS AS NECESSARY TO PREVENT SEEPAGE.
- 12. LOCATE MINOR LEAKS AND REPAIR AS REQUIRED.
- 13, PROVIDE SUMP PUMPS AS REQUIRED TO MAINTAIN A DRY EXCAVATION.
- 14. BYPASS PIPING SHALL BE INSTALLED AND REMOVED PER MANUFACTURER'S INSTRUCTIONS.

# **DEWATERING & BY-PASS PIPING GENERAL PROCEDURE**

- THE CONTRACTOR SHALL SUBMIT A BY-PASS PIPING AND A LOCAL DEWATERING PLAN TO THE ENGINEER FOR REVIEW PRIOR TO COMMENCEMENT OF WORK. ALL WORK SHALL BE IN COMPLIANCE WITH THE ISSUED ORDER OF CONDITIONS BY THE BARNSTABLE CONSERVATION COMMISSION
- CLEARING AND GRUBBING FOR BYPASS PIPING AND ACCESSORIES SHALL BE COORDINATED WITH THE ENGINEER AND THE BARNSTABLE CONSERVATION AGENT PRIOR TO ANY WORK ACTIVITIES. NO WORK SHALL BEGIN UNTIL AUTHORIZATION IS GRANTED BY ENGINEER AND CONSERVATION COMMISSION.
- INSTALL TEMPORARY SANDBAG DAM SYSTEM. AS SHOWN ON THIS SHEET AND IN ACCORDANCE WITH THE DETAIL SHOWN ON SHEET 101. COORDINATE WITH ENGINEER AND CONSERVATION AGENT FOR FINAL LOCATIONS OF THE TEMPORARY SANDBAG DAM SYSTEM.
- SUPER SAND BAGS MAY BE USED IN PLACE OF DOWNSTREAM PORTADAM AS APPROVED BY THE ENGINEER.
- DEWATERING PUMP INTAKE(S) WITHIN THE TEMPORARY SANDBAG DAM SYSTEM SHALL BE EQUIPPED WITH A 1/4" SCREEN MESH SURROUNDING THE PUMP INTAKES AND PROPERLY SECURED TO THE STREAM/CULVERT/POND BOTTOM. TEMPORARY STONE SHALL BE USED TO MINIMIZE UPTAKE OF SEDIMENT.
- THE CONTRACTOR SHALL PROVIDE A DISSIPATER AT THE END OF THE BYPASS PIPE AND DEWATERING PUMP DISCHARGE PIPE OUTLET(S) TO PREVENT ANY STREAMBED DISTURBANCE DOWNSTREAM OF THE WORK. ALL DISCHARGE ACTIVITIES SHALL OCCUR WITHIN THE CONTAINMENT OF THE DOWNSTREAM **EROSION CONTROLS.**
- ALL FOUNDATIONS AND EXCAVATIONS SHALL OCCUR IN "THE DRY". GROUNDWATER SHALL BE LOWERED BY A MINIMUM OF 2' BELOW THE BASE OF THE EXCAVATION.

1" = 10'

THE CONTRACTOR SHALL MAINTAIN SPILL KITS ON SITE AT ALL TIMES.



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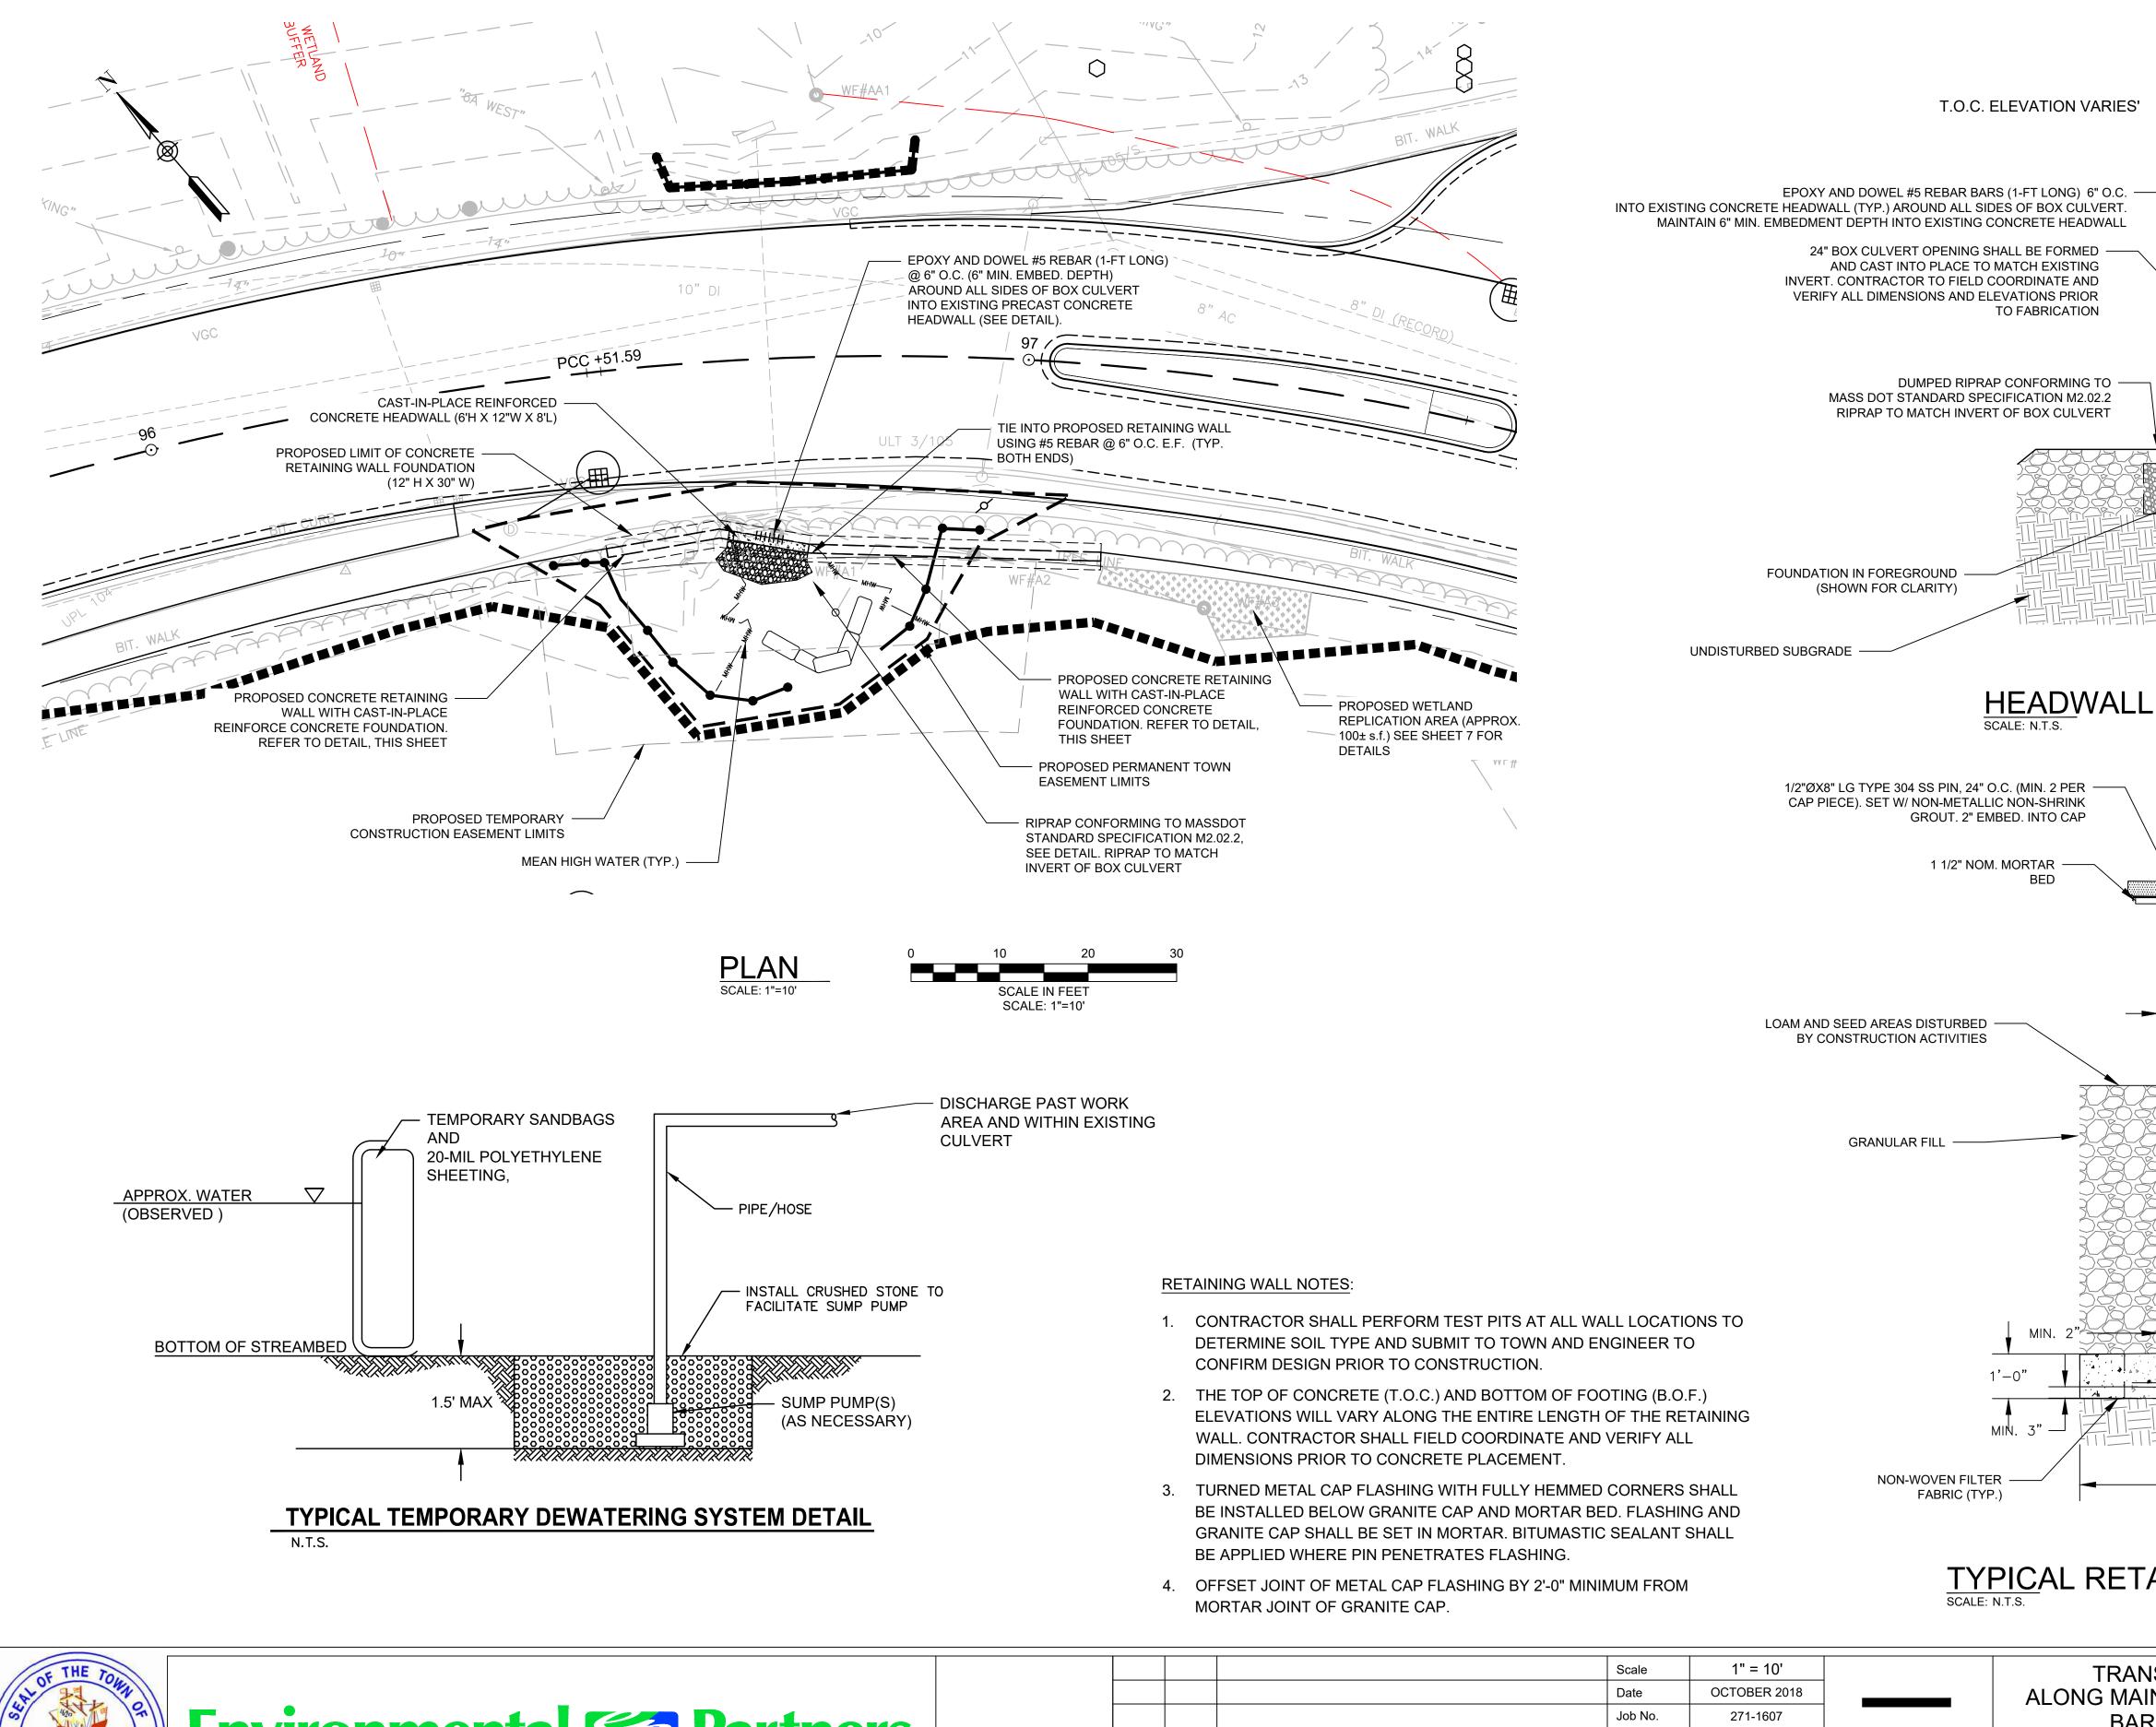
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TRANSPORTATION IMPROVEMENTS ALONG MAIN STREET (ROUTE 6A) AND MILLWAY BARNSTABLE, MASSACHUSETTS

**EXISTING CONDITIONS AND SEDIMENT CONTROL PLAN** 

NOT FOR CONSTRUCTION

Sheet No.



HEADWALL CONNECTION DETAIL 4" THICK GRANITE STONE CAP, SLOPE 1/8" PER FOOT TO EXTERIOR, ELEVATION VARIES - SS CON/ METAL CAP FLASHING W/ TURNED ENDS - 1" NOM. MORTAR **COLLAR JOINT** - ROUNDED RIVER STONE VENEER, 4" THICK (TYP.) SS TYPE 304 METAL STONE TIES W/ 12 GAUGE BASE & 1/4" Ø ADJUSTABLE WIRE TIE (H&B DW-10HS OR EQUAL). SET INTO 12" WIDE CONCRETE W/ SS CONC. SCREWS, SPACING 5/8" PREMOLDED JOINT FILLER BETWEEN WALL AND SIDEWALK PEDESTRIAN SIDEWALK WITH SIDEWALK SUBBASE REFER TO TYPICAL SIDEWALK DETAIL ON SHEET 05 GRANULAR FILL FROM TOP OF FOOTING UP TO PEDESTRIAN SIDEWALK SUBBASE - #5 REBAR @ 6" H&V, E.F. - #5 REBAR @ 6" O.C. 12" MIN. OF 3/4" CRUSHED STONE - 3-#5 REBAR, CONTINUOUS - #5 REBAR @ 9" O.C. UNDISTURBED SUBGRADE TYPICAL RETAINING WALL DETAIL TRANSPORTATION IMPROVEMENTS NOT FOR CONSTRUCTION ALONG MAIN STREET (ROUTE 6A) AND MILLWAY Sheet No. BARNSTABLE, MASSACHUSETTS PROPOSED CULVERT PLAN AND DETAILS

CAST-IN-PLACE REINFORCED CONCRETE HEADWALL (SEE RETAINING WALL DETAIL FOR ADDITIONAL DETAILS).

FOR FALL PROTECTION ALONG SIDEWALK

— — INV. EL.=7.49±'

— T.O.F. EL.=5.99±'

— — B.O.F. EL.=4.99±'

COORDINATE FINAL HEIGHT OF WALL WITH ENGINEER PRIOR TO

FABRICATION. WALL SHALL MAINTAIN A MINIMUM OF 42" HEIGHT

PEDESTRIAN SIDEWALK WITH SIDEWALK SUBBASE

- EXISTING REINFORCED CONCRETE HEADWALL

REFER TO TYPICAL SIDEWALK DETAIL ON SHEET

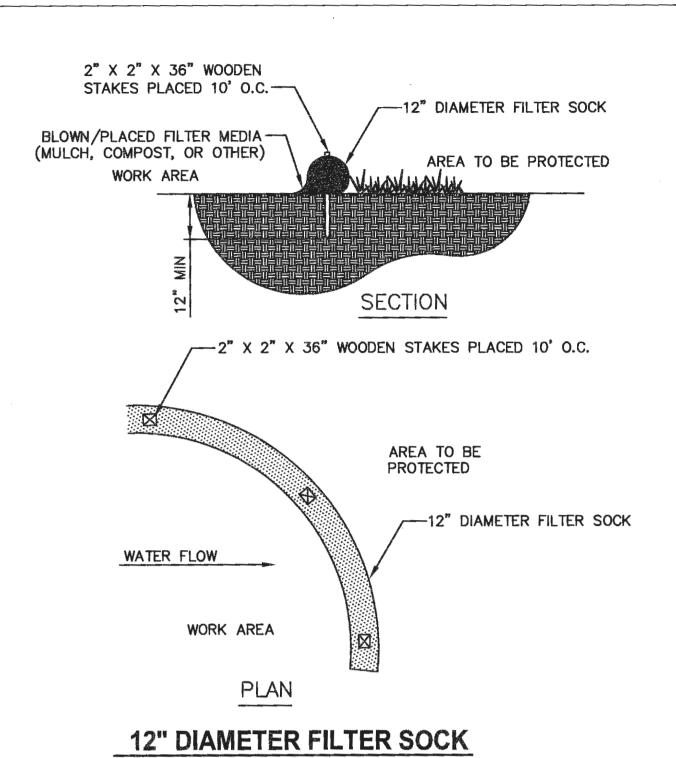


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DISCHARGE PAST WORK AREA AND WITHIN EXISTING CULVERT TEMPORARY SANDBAGS AND 20-MIL POLYETHYLENE SHEETING,  $\nabla$ APPROX. WATER - PIPE/HOSE (OBSERVED ) - INSTALL CRUSHED STONE TO FACILITATE SUMP PUMP BOTTOM OF STREAMBED 1.5 MAX SUMP PUMP(S) (AS NECESSARY)

TYPICAL TEMPORARY DEWATERING SYSTEM DETAIL

LOAM AND SEED (DISTURBED AREAS)

--PLACE SILT SACK UNDER EXISTING CATCH BASIN GRATE FRAME AND GRATE-EXISTING PAVEMENT 

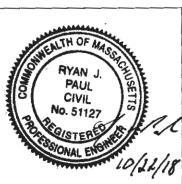
N.T.S.

- 1. SILT SACKS SHALL BE INSPECTED WEEKLY AND ACCUMULATED SILT REMOVED TO ALLOW CATCH BASIN TO FUNCTION PROPERLY.
- 2. SILT SACK AS MANUFACTURED BY ACF ENVIRONMENTAL (800-448-3636) OR APPROVED EQUAL.

CATCH BASIN SILT SACK DETAIL







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TRANSPORTATION IMPROVEMENTS ALONG MAIN STREET (ROUTE 6A) AND MILLWAY BARNSTABLE, MASSACHUSETTS

CIVIL DETAILS

NOT FOR CONSTRUCTION Sheet No.

N.T.S. NEW ENGLAND CONSERVATION/WILDLIFE SEED MIX PER NEW ENGLAND WETLAND PLANTS, INC., AMHERST, MA OR EQUAL. FINISH GRADE-FINISH SUBGRADE HIGH ORGANIC SOIL/LOAM (8% - 12% ORGANIC CONTENT) COMPACTED SUBGRADE LOAM IS NATIVE TO CAPE COD WITH LOW NITROGEN NOTE: INSTALL CURLEX CL EROSION CONTROL BLANKET AS MANUFACTURED BY AMERICAN EXCELSIOR COMPANY (OR APPROVED EQUAL) ON ALL LOAM AND SEEDED SLOPES 3:1 OR STEEPER.

1. ALL SHRUBS SHALL BE PLANTED 6-FOOT ON CENTER IN

CLUSTERS CONTAINING THE FOLLOWING: RED

ELEVATION OF THE EXISTING WETLAND.

2. THE REPLICATION AREA SHALL BE EXCAVATED TO THE

3. 4 SHRUBS SHALL BE PLANTED PER EVERY 100 SQUARE

WETLAND REPLICATION DETAIL

CHOKEBERRY, WINTERBERRY.

FEET OF WETLAND REPLICATION.

- NEW ENGLAND CONSERVATION/WILDLIFE SEED MIX PER NEW ENGLAND WETLAND

PLANTS, INC., AMHERST, MA OR EQUAL.

HIGH ORGANIC SOIL/LOAM

(8% - 12% ORGANIC CONTENT)
LOAM IS NATIVE TO CAPE COD
WITH LOW NITROGEN

JUTE MATTING FOR BANK

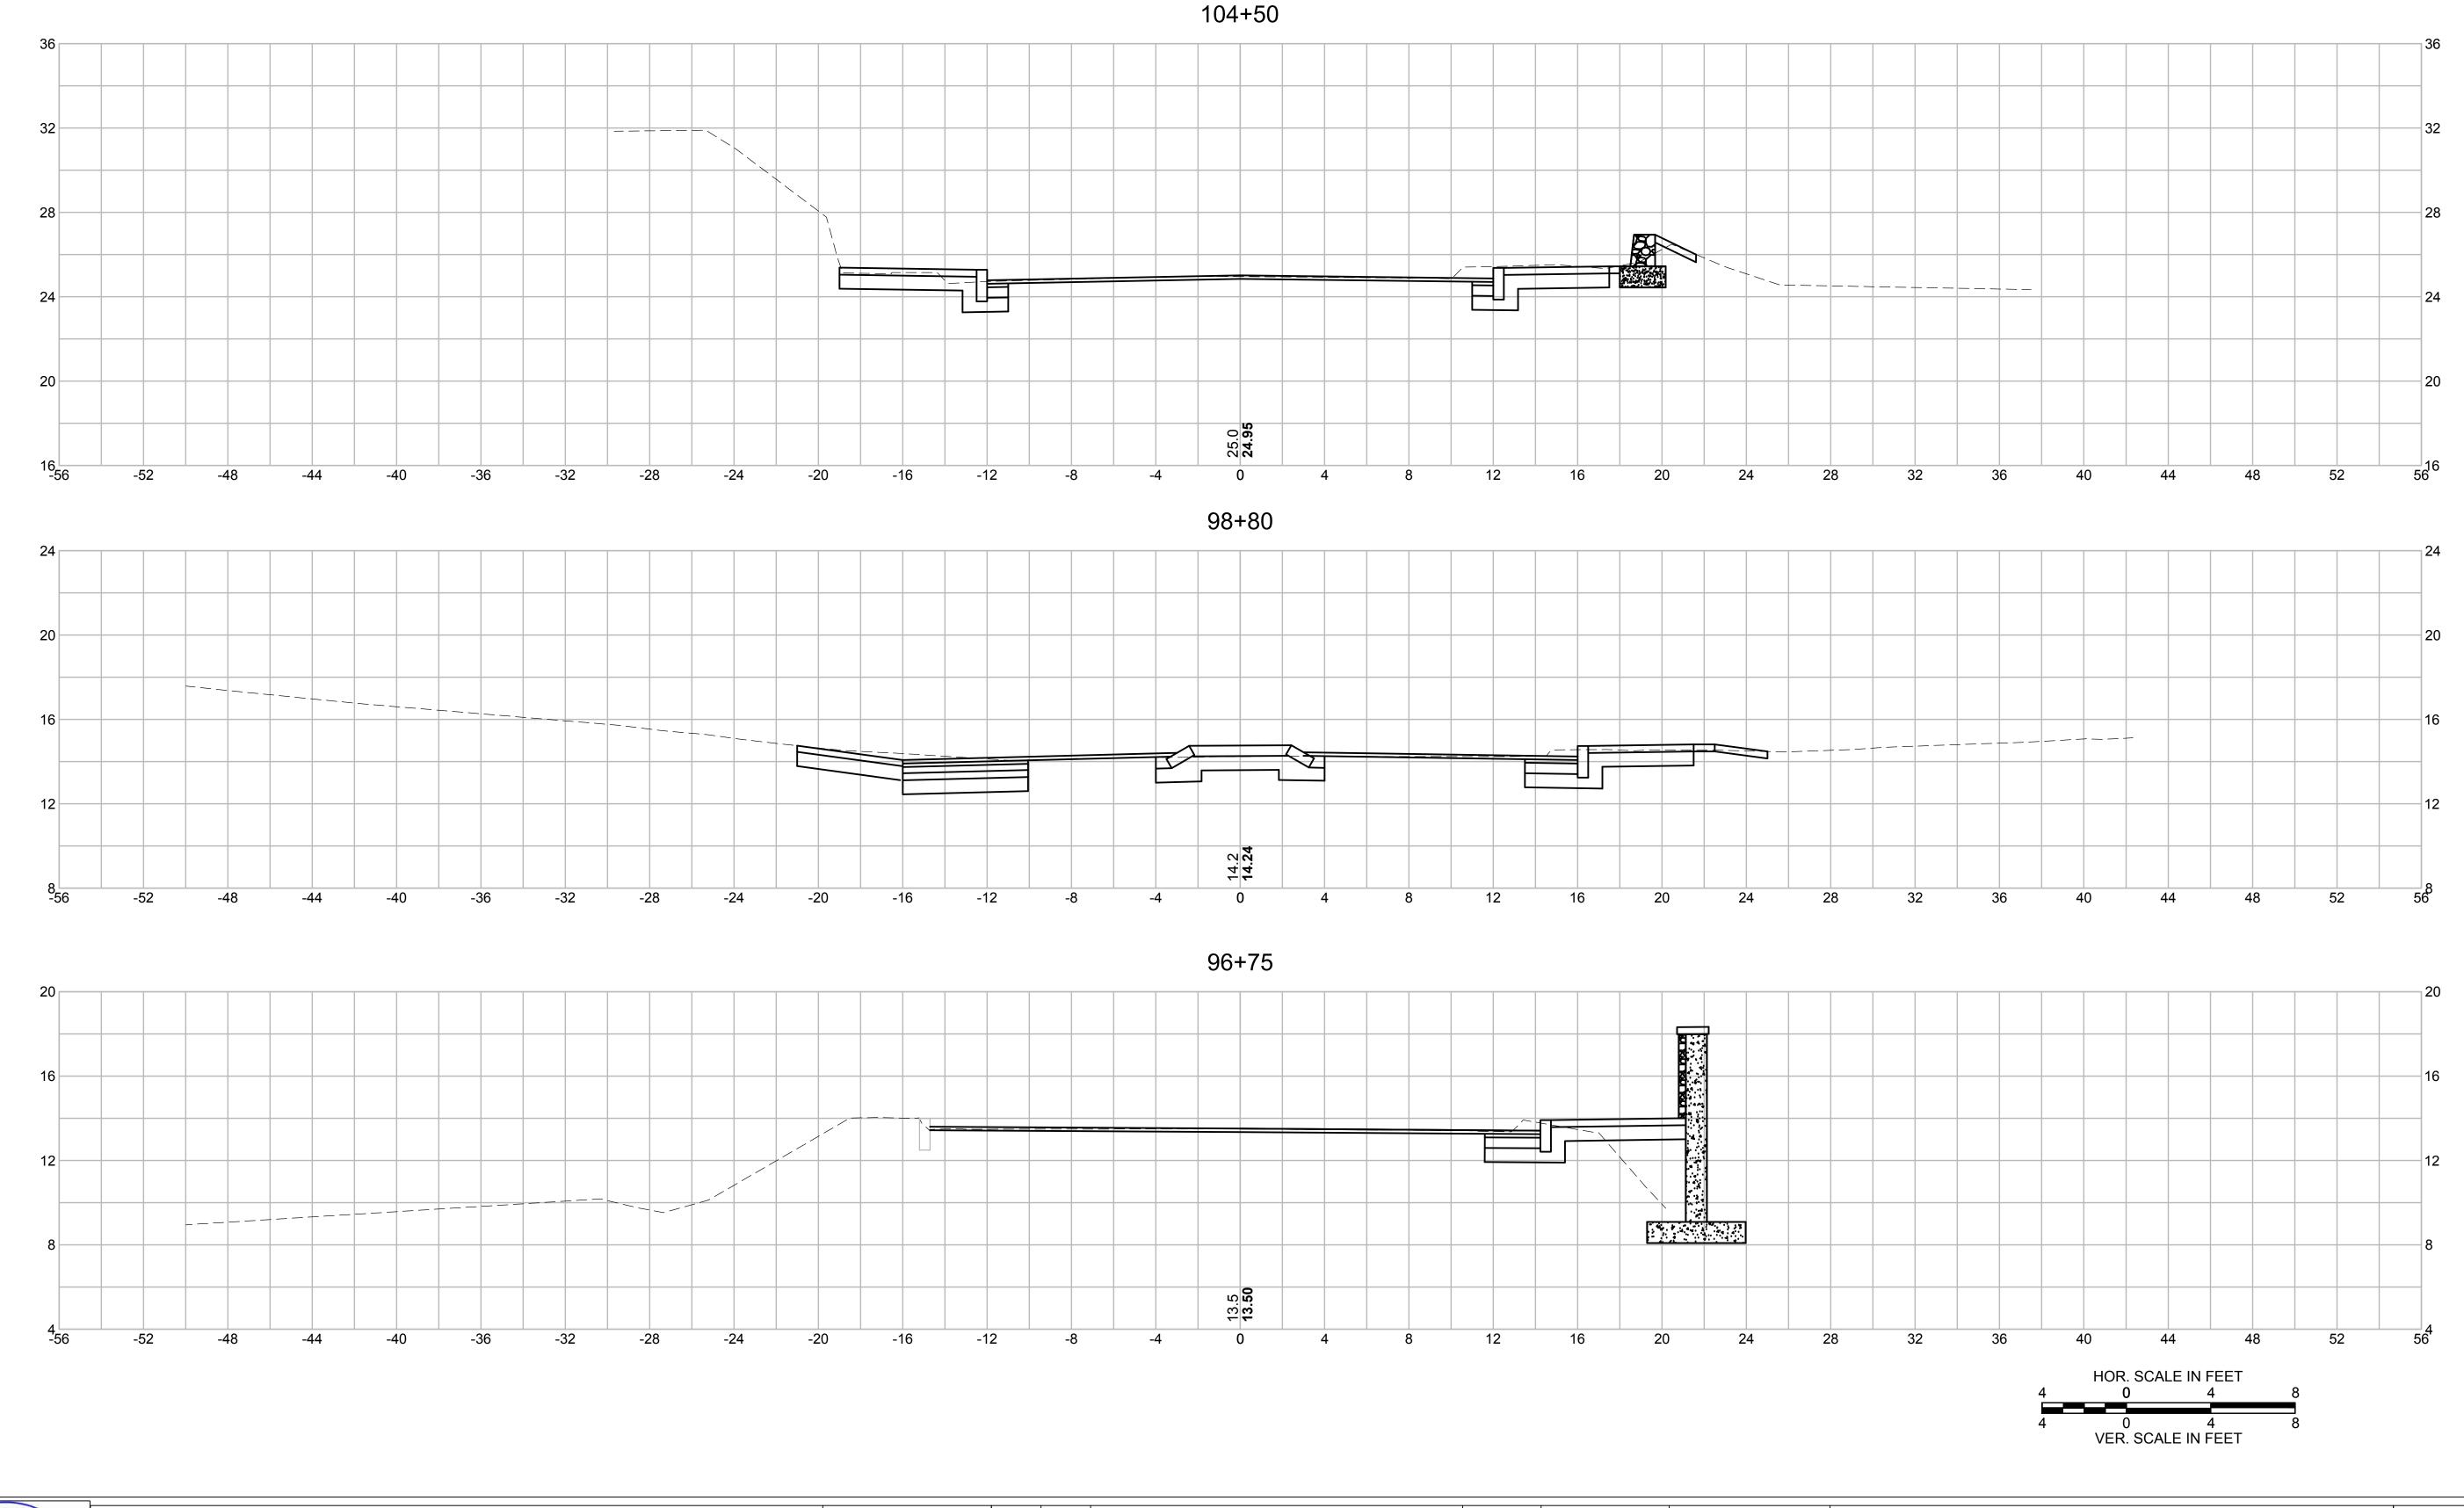
STABILIZATION

WINTERBERRY AND RED CHOKEBERRY: -

FINISH SUBGRADE

FINISH SUBGRADE

COMPACTED SUBGRADE

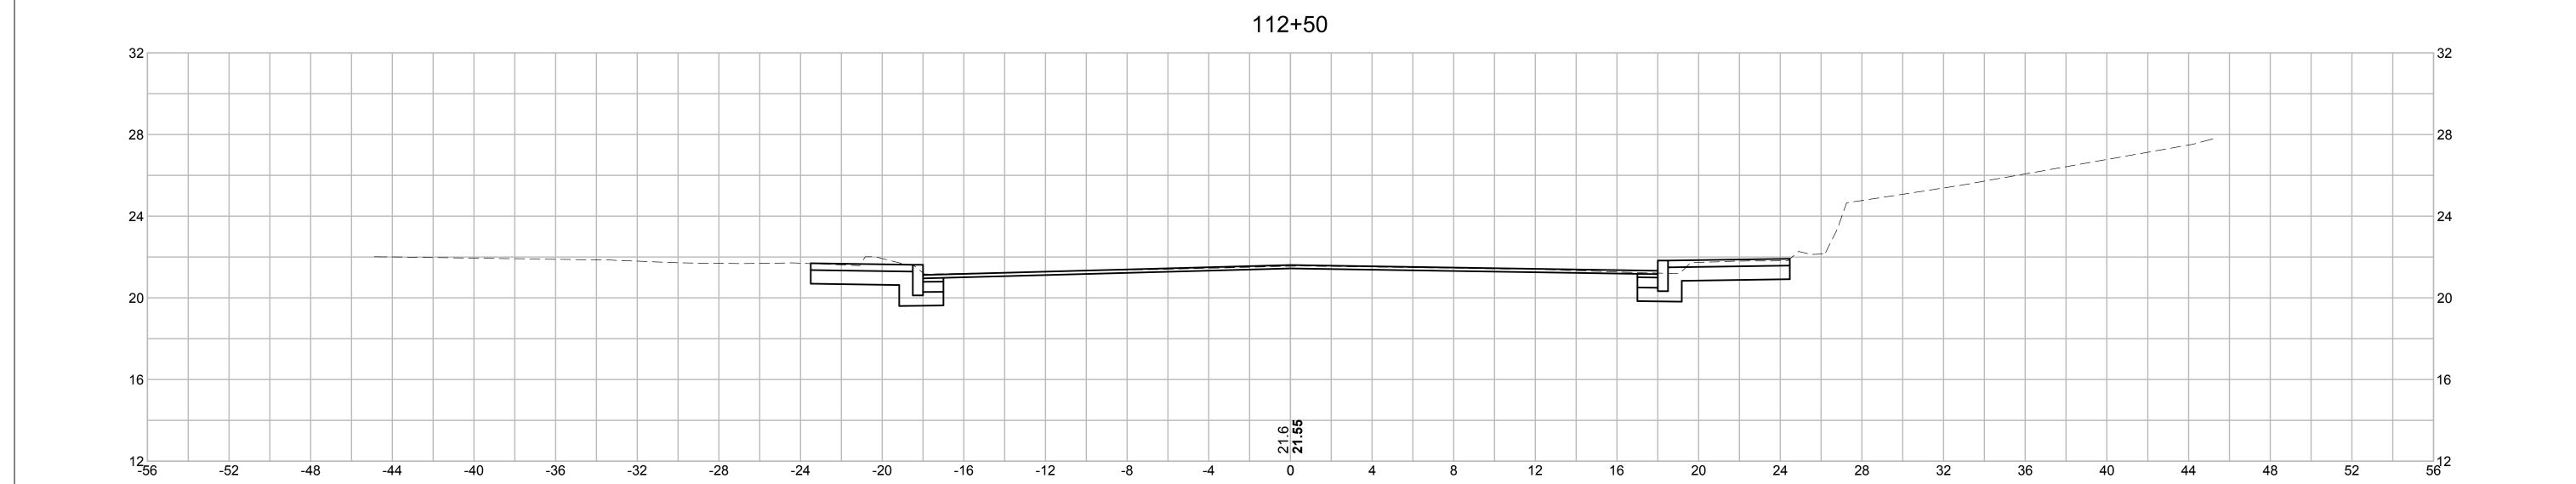


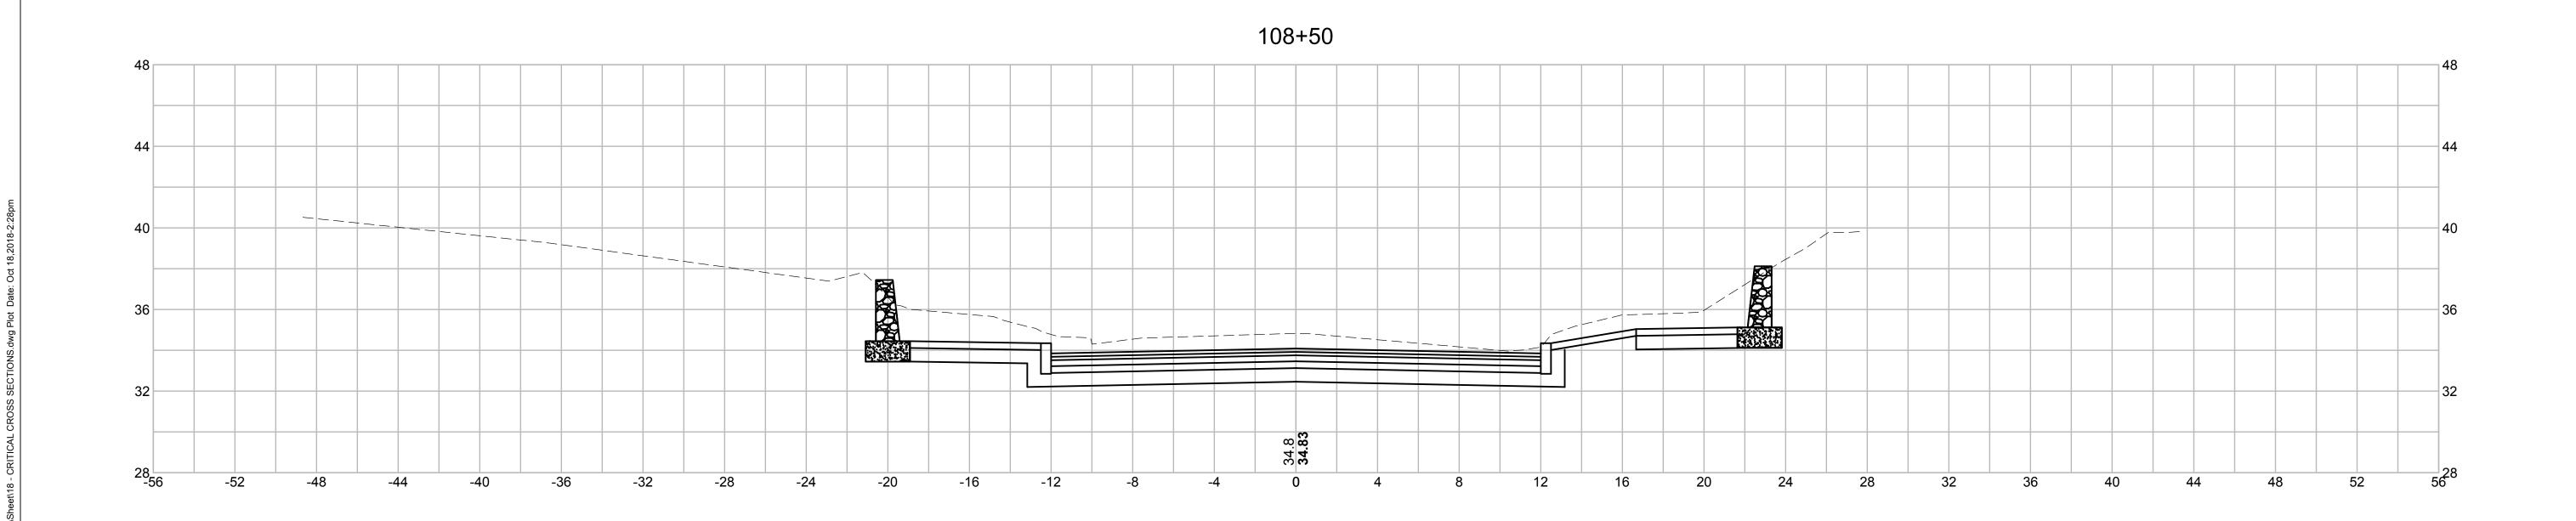
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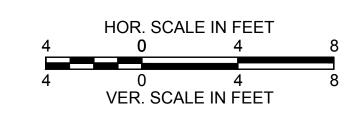
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MAIN STREET CRITICAL CROSS SECTIONS - 01 NOT FOR CONSTRUCTION

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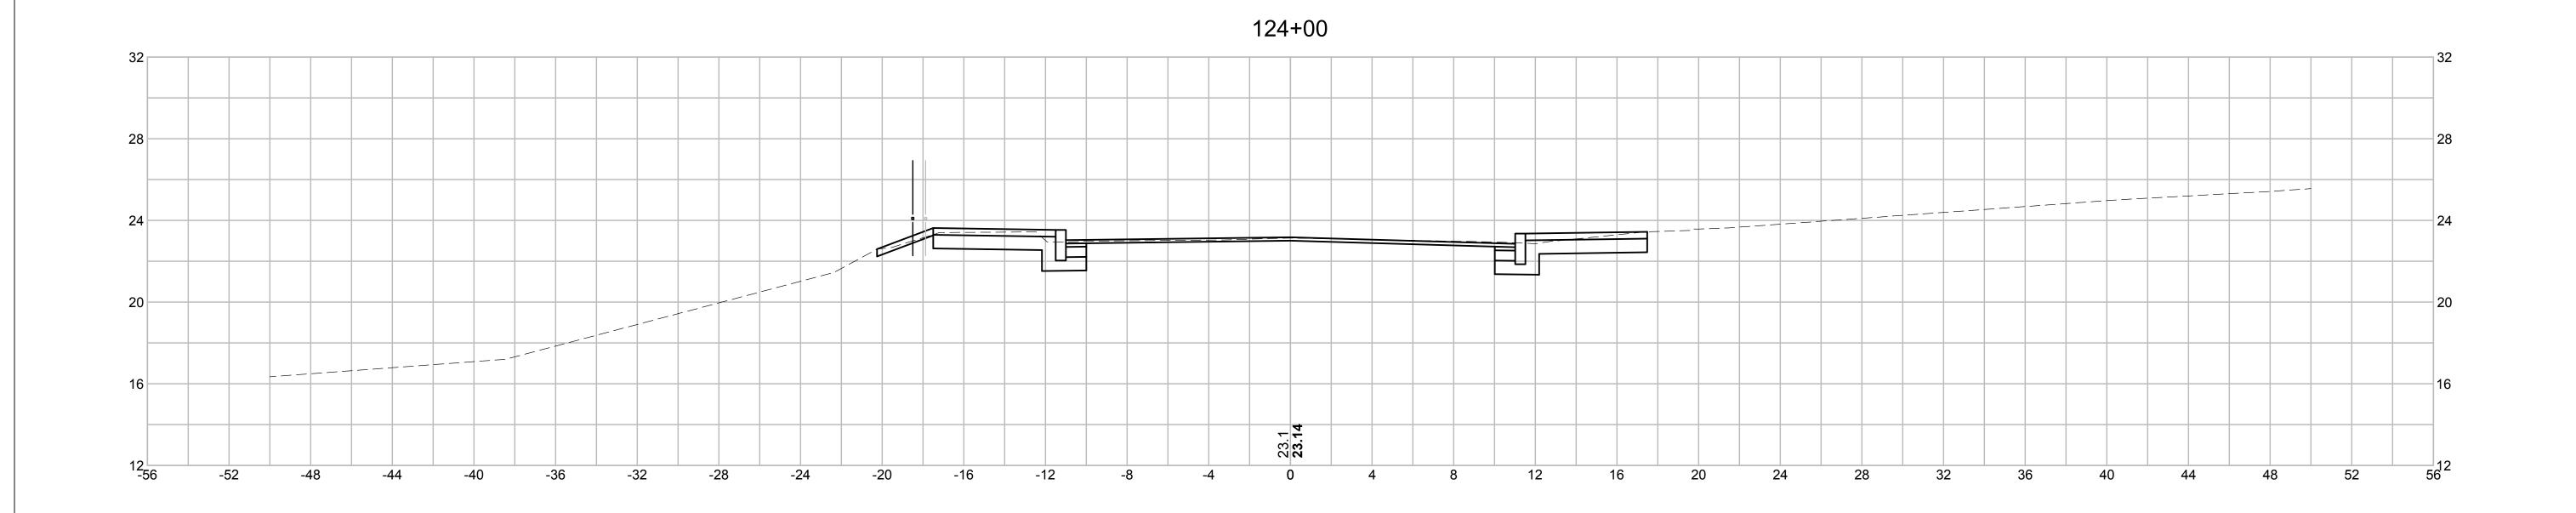


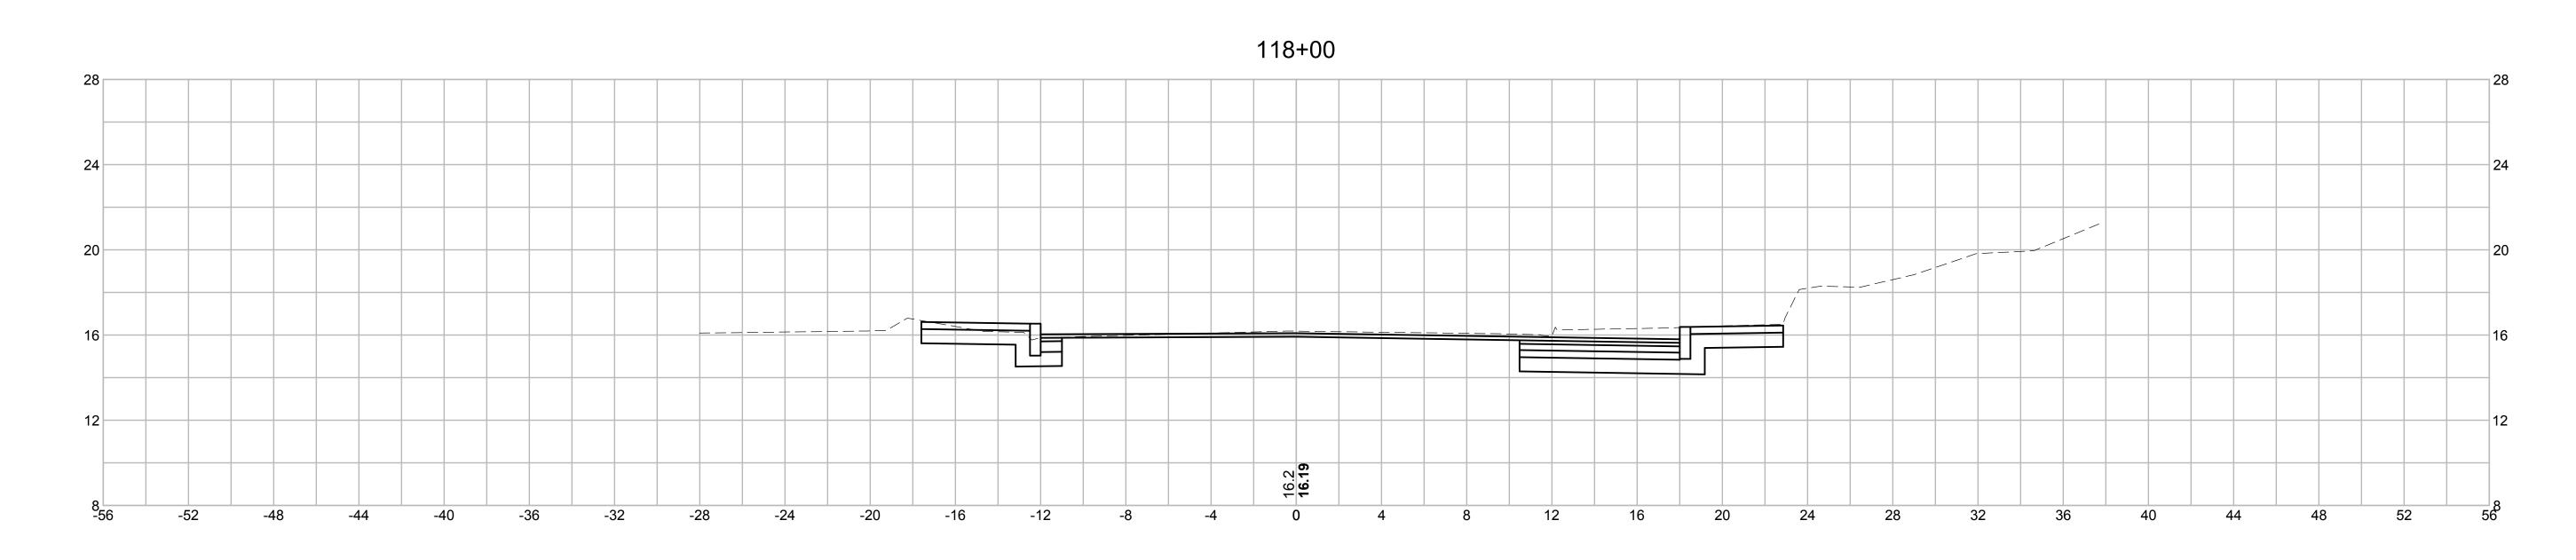


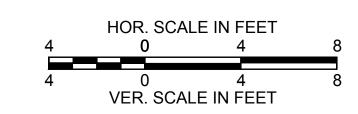


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MAIN STREET CRITICAL CROSS SECTIONS - 02 NOT FOR CONSTRUCTION
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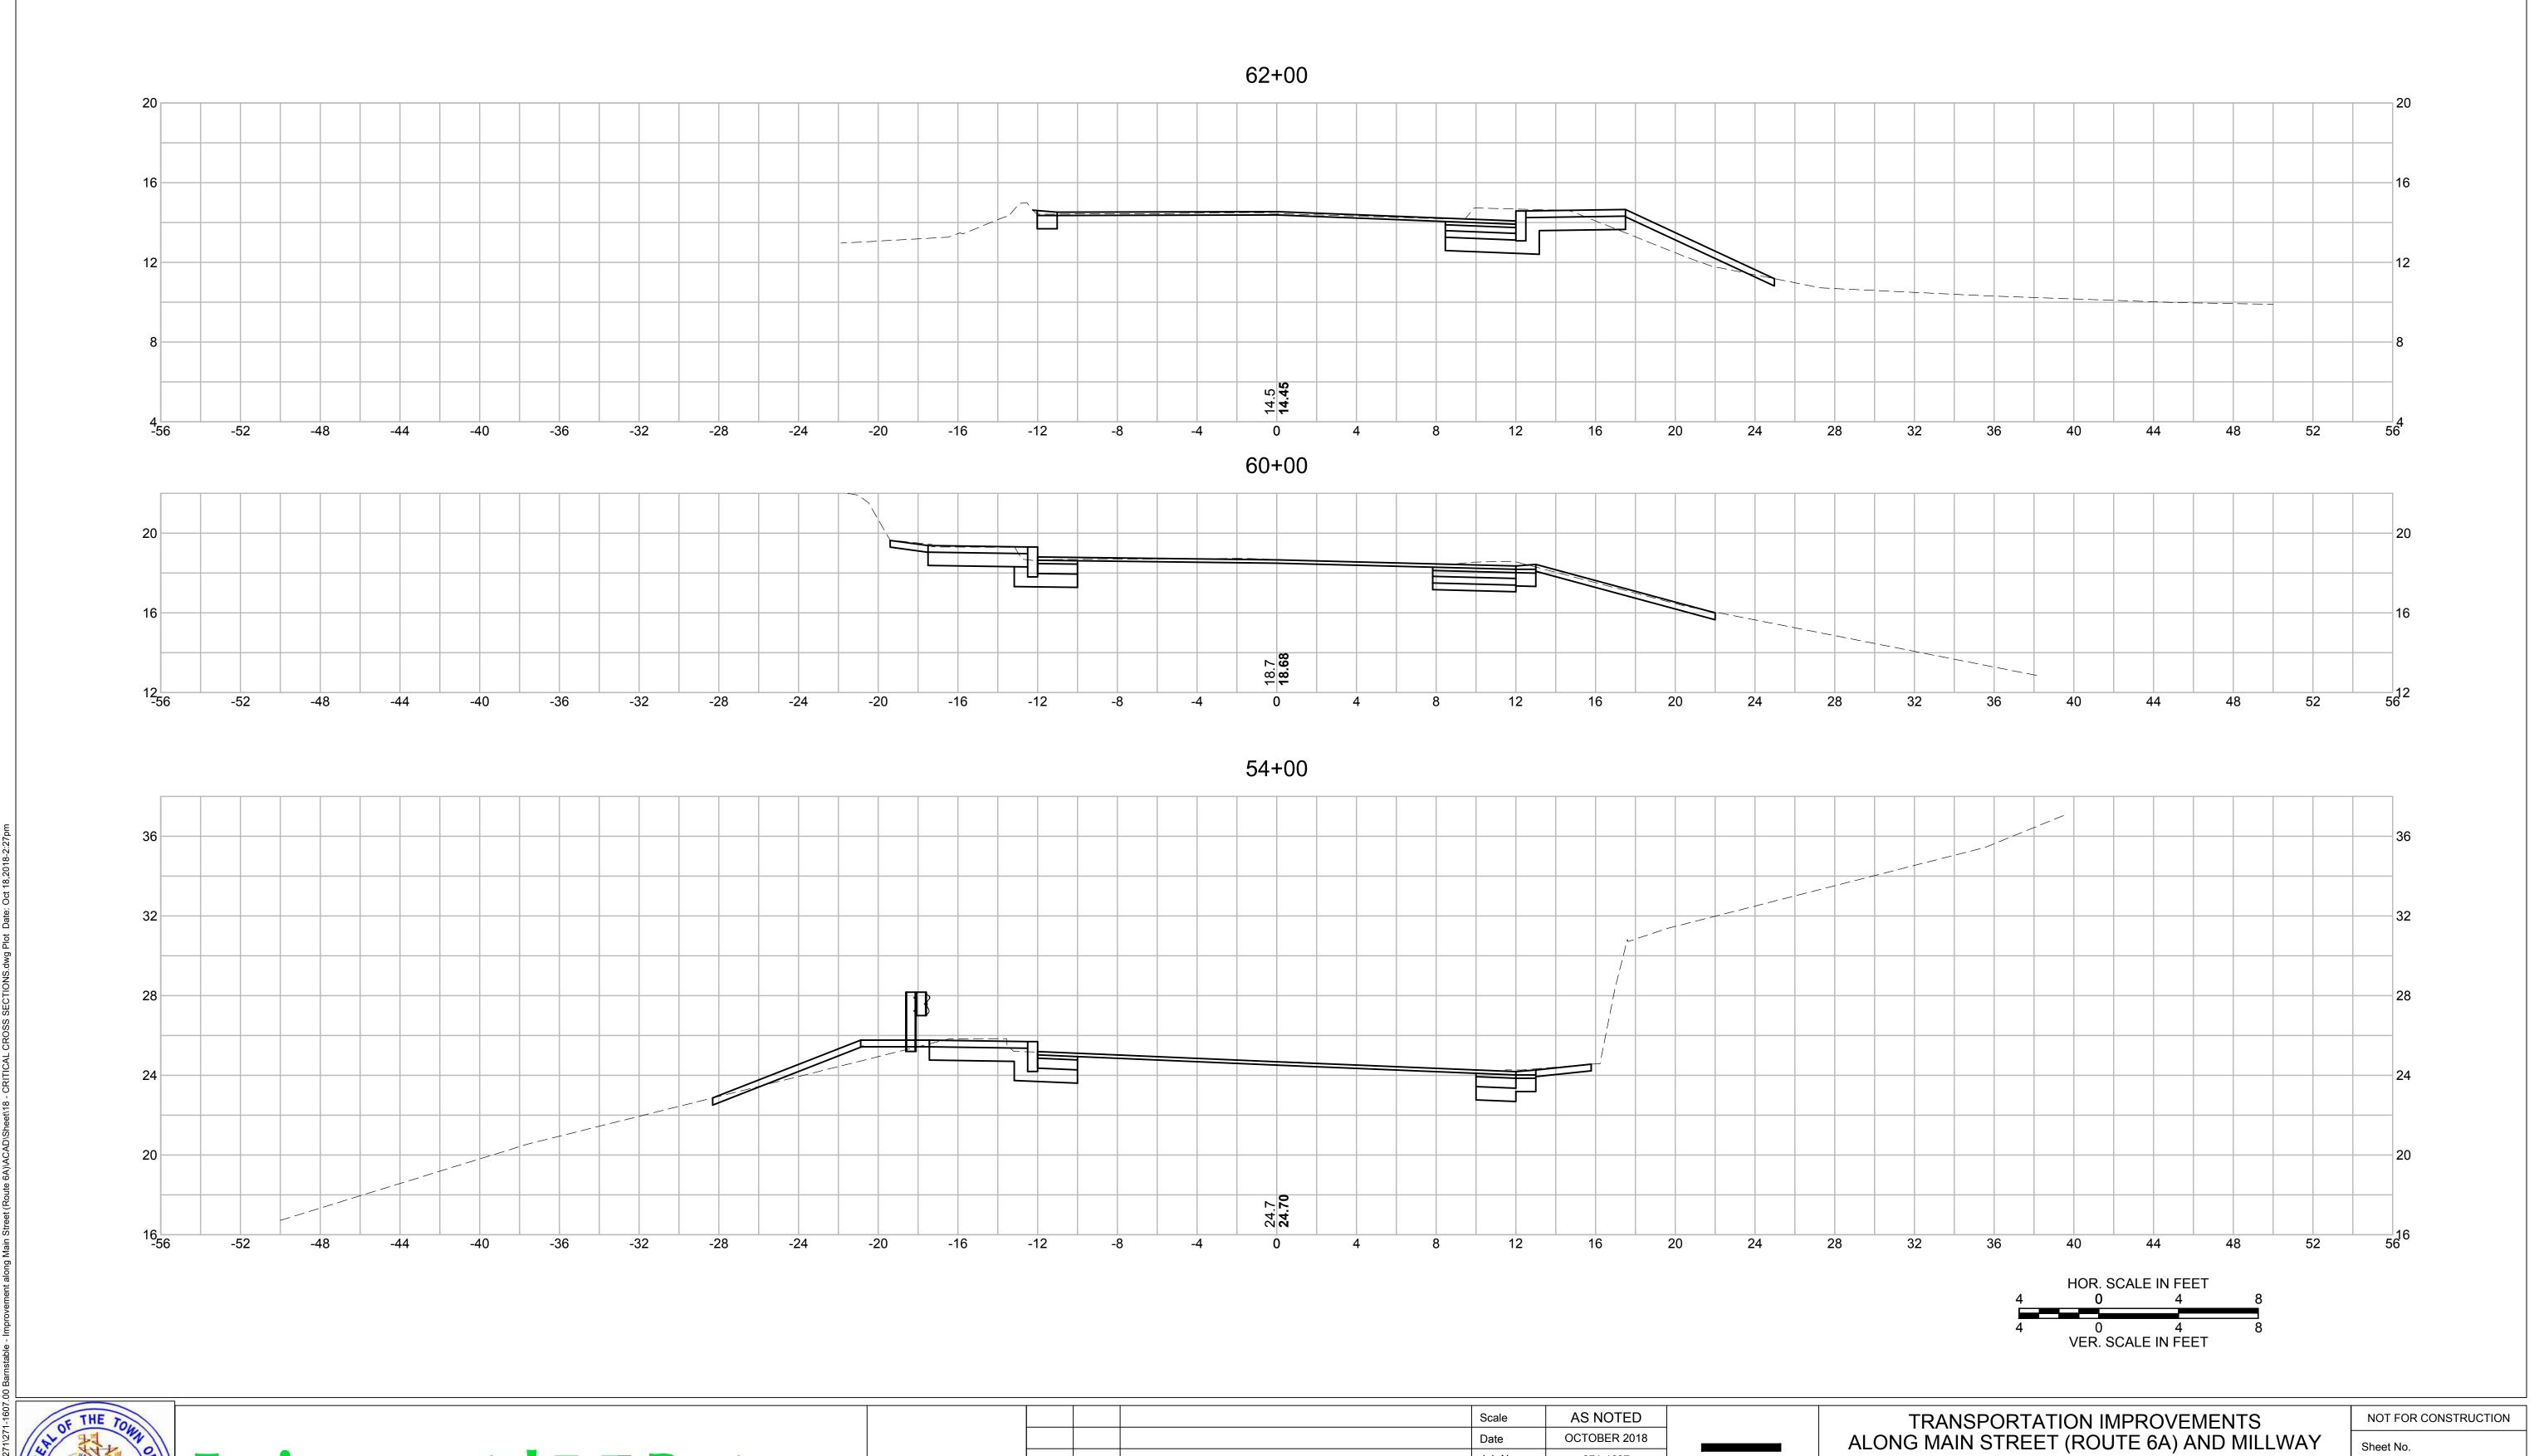






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MAIN STREET CRITICAL CROSS SECTIONS - 03 NOT FOR CONSTRUCTION
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03 10/19/18 REVISED FINAL SUBMISSION

01 08/01/18 DRAFT PRELIMINARY DESIGN SUBMISSION

02 08/22/18 FINAL SUBMISSION

MARK DATE DESCRIPTION

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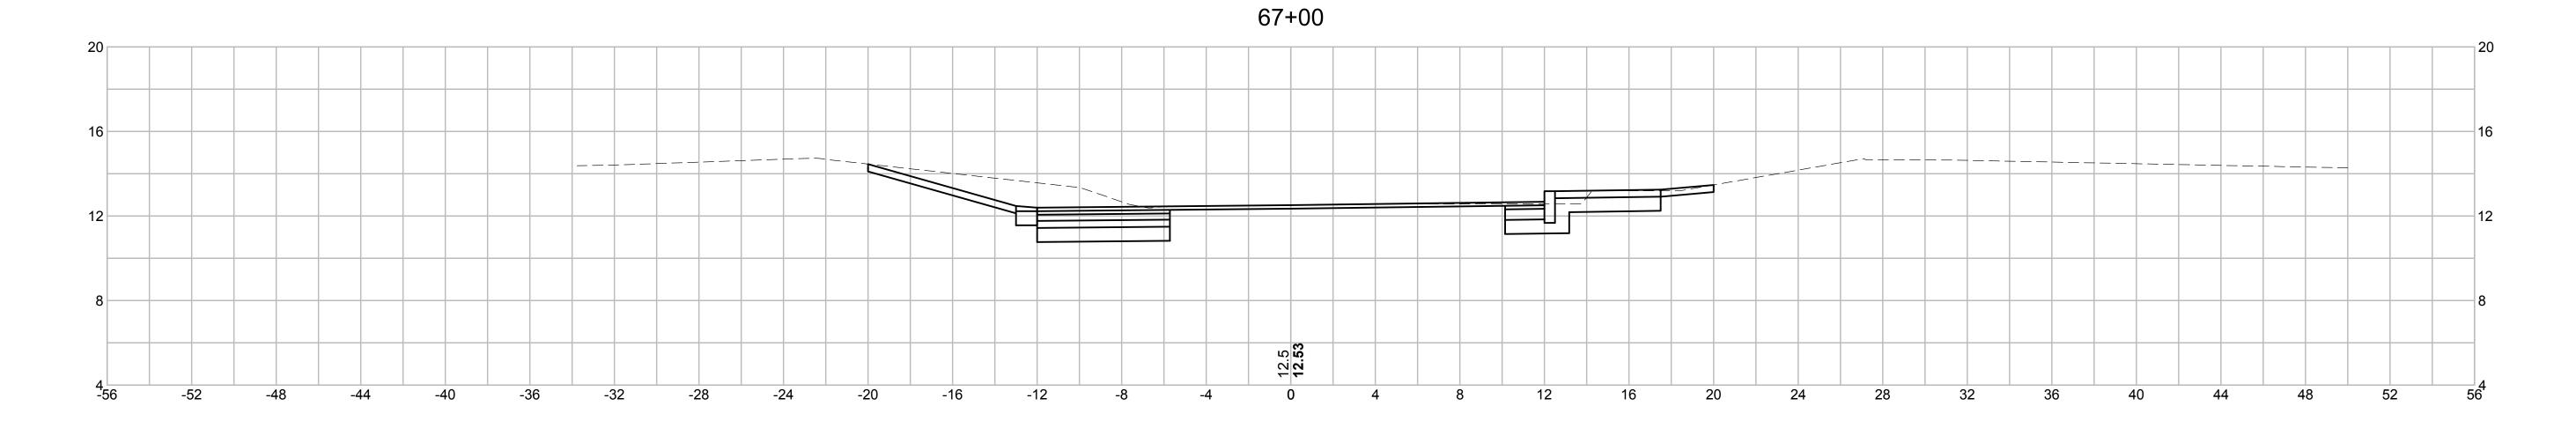
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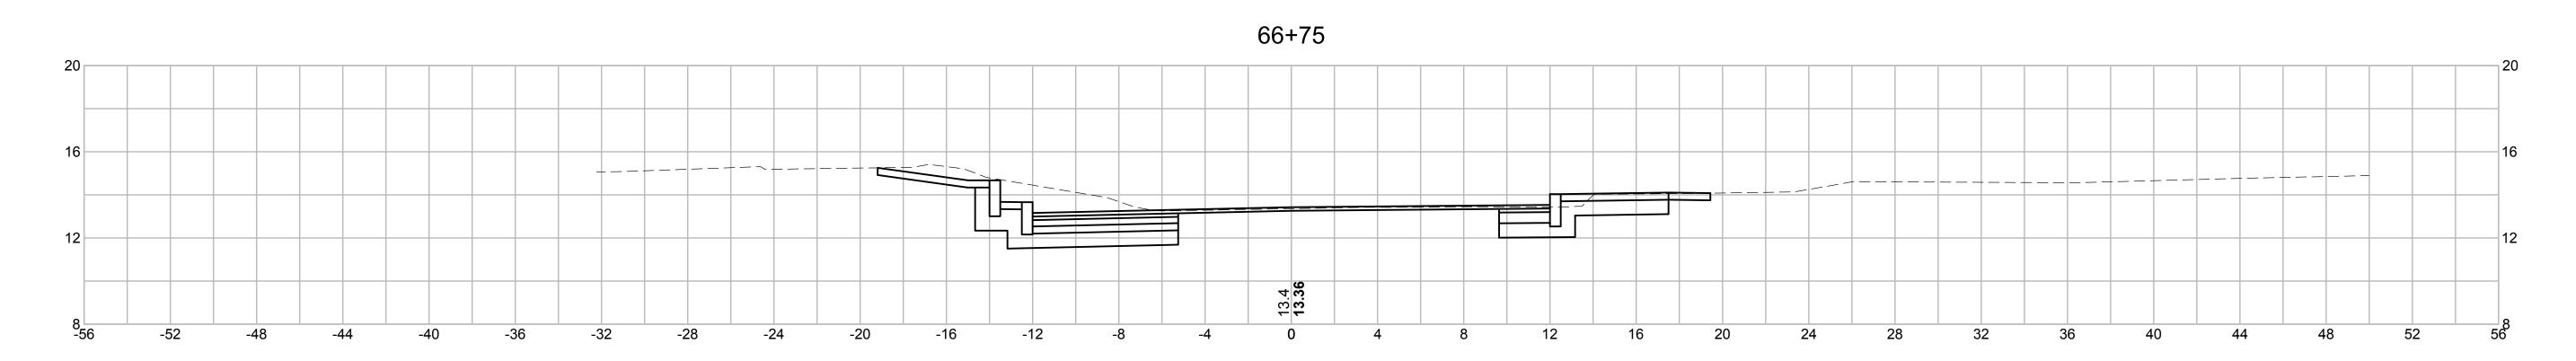
**MILLWAY** 

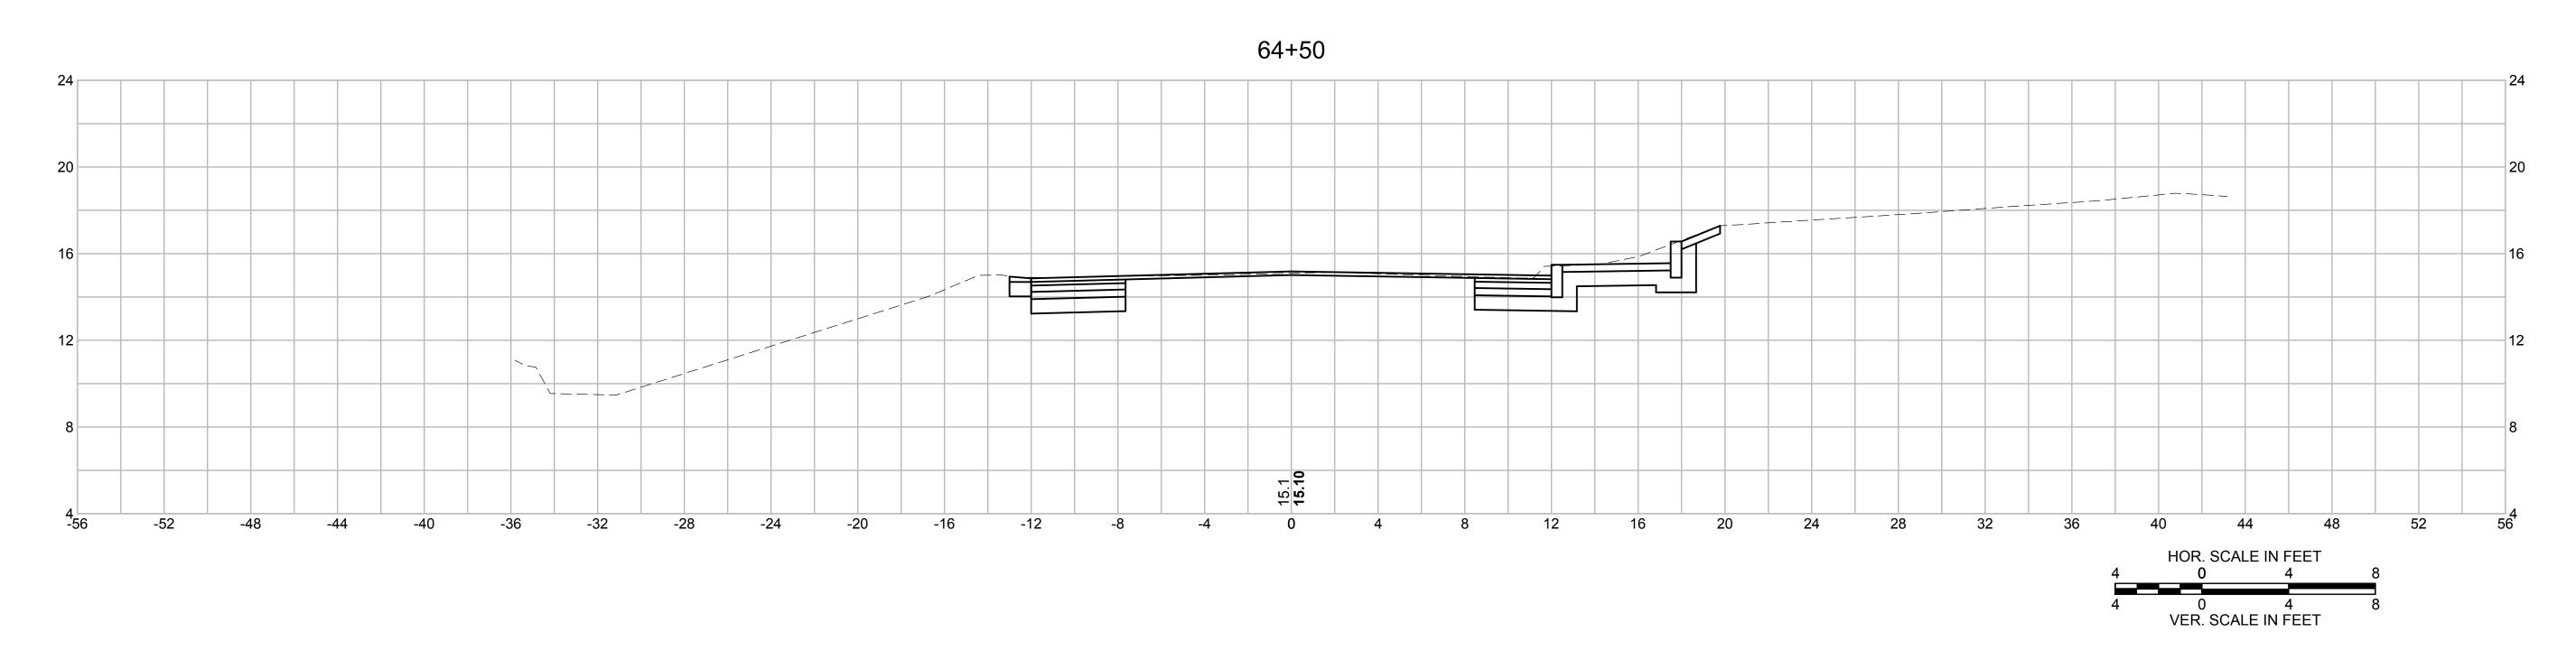
CRITICAL CROSS SECTIONS - 01

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> MILLWAY CRITICAL CROSS SECTIONS - 02

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